


A1 Birtley to Coal House

Scheme Number: TR010031

**2.7 Structures Engineering Drawings
and Sections**

APFP Regulation 5(2)(o)
Planning Act 2008

Infrastructure Planning (Applications: Prescribed
Forms and Procedure) Regulations 2009

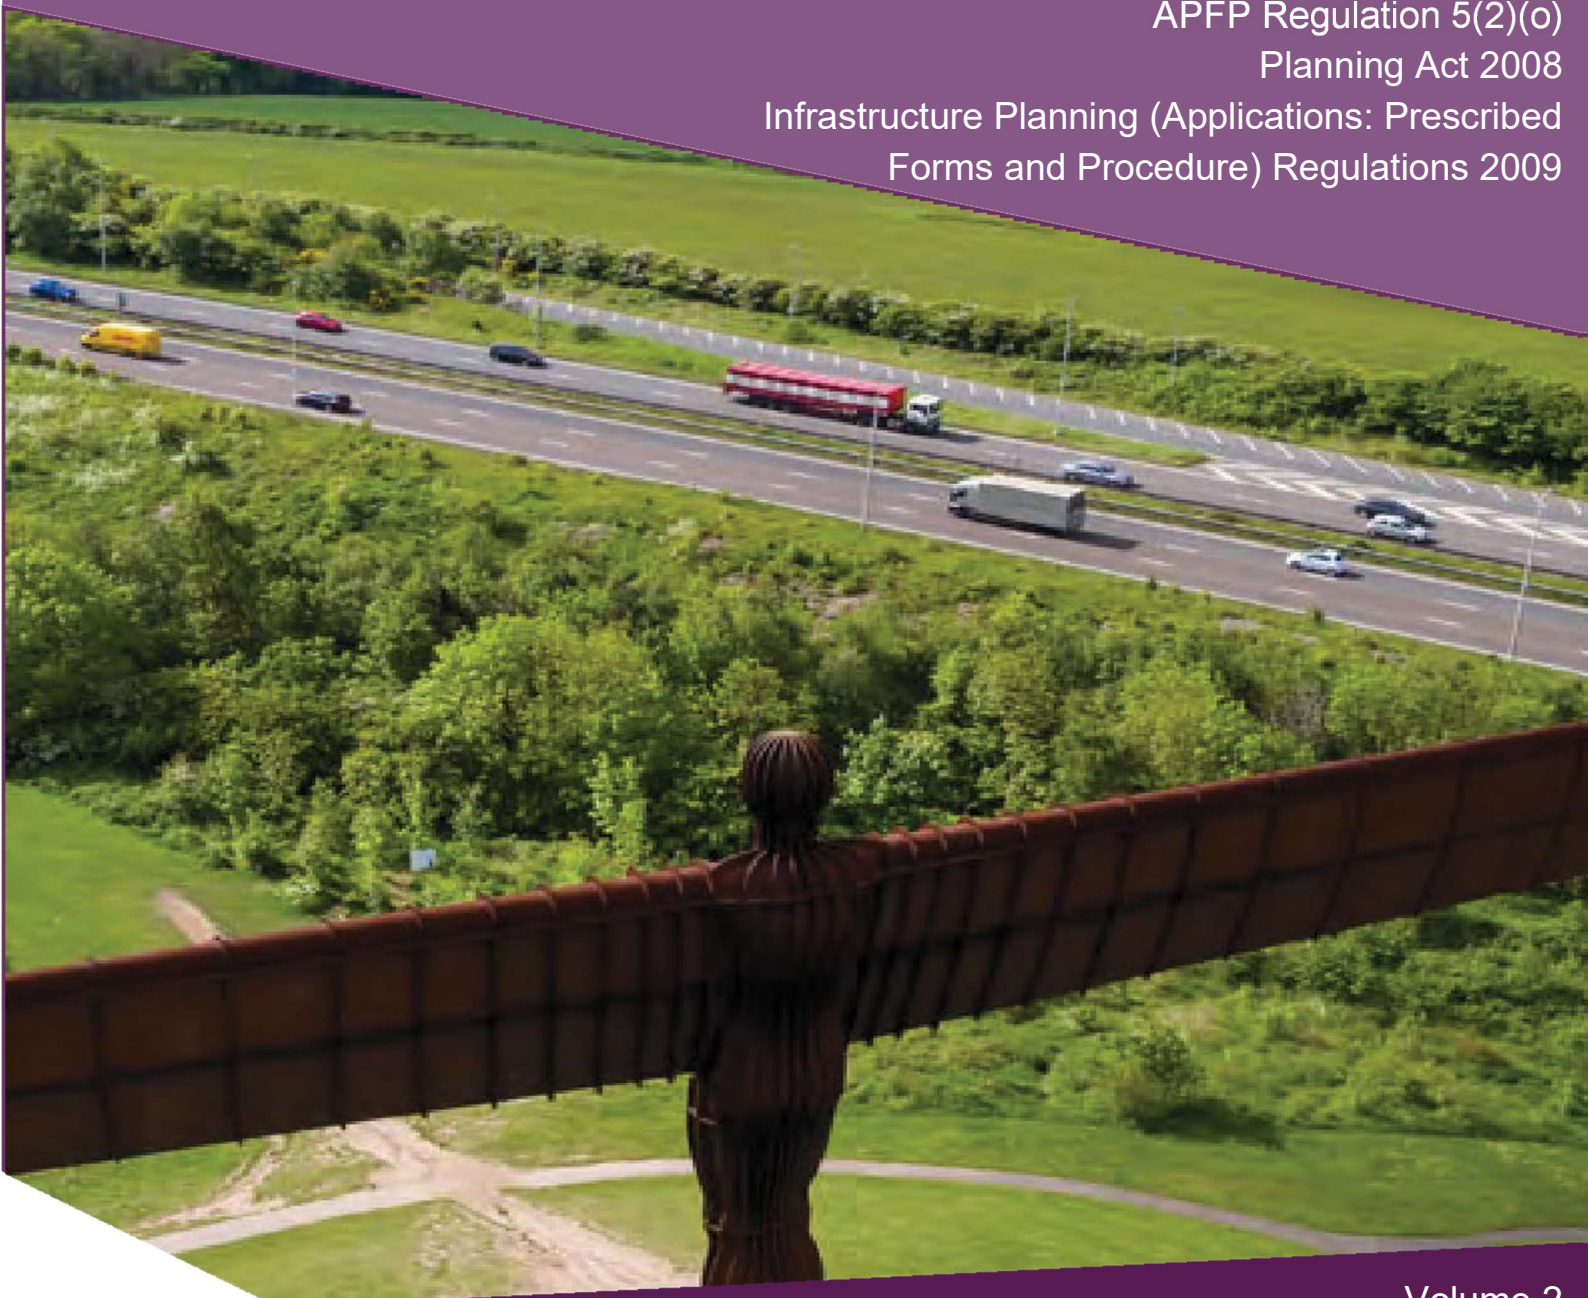

Infrastructure Planning

Planning Act 2008

**The Infrastructure Planning
(Applications: Prescribed Forms and
Procedure - APFP) Regulations 2009**

**The A1 Birtley to Coal House
Development Consent Order 20[xx]**

STRUCTURES ENGINEERING DRAWINGS AND SECTIONS

Regulation Reference:	APFP Regulation 5(2)(o)
Planning Inspectorate Scheme Reference	TR010031
Application Document Reference	TR010031/APP/2.7
Author:	A1 Birtley to Coal House Project Team, Highways England

Version	Date	Status of Version
Rev 1	25/02/2020	Examination Deadline 2 update

CONTENTS

1	INTRODUCTION.....	4
1.1	Purpose of this Document.....	4
2	SCHEDULE OF PLANS INCLUDED IN THIS APPLICATION DOCUMENT	5

1 INTRODUCTION

1.1 Purpose of this Document

1.1.1 These Structures Engineering Drawings and Sections (the "Drawings") relates to an application made by Highways England (the "Applicant") to the Planning Inspectorate (the "Inspectorate") under the Planning Act 2008 (the "2008 Act") for a Development Consent Order (DCO). If made, the DCO would grant consent for the Applicant to undertake the A1 Birtley to Coal House (the "Scheme"). A detailed description of the Scheme can be found in **Chapter 2** of the Environmental Statement (ES) (**Application Document Reference: TR010031/APP/6.1**).

1.1.2 These Drawings comprises part of the suite of Application documentation and are included in the Application in compliance with Regulation 5(2)(o), of the Infrastructure Planning (Applications: Prescribed Forms and Procedure) Regulations 2009, which requires:

"5(2)(o) any other plans, drawings and sections necessary to describe the proposals for which development consent is sought, showing details of design, external appearance, and the preferred layout of buildings or structures, drainage, surface water management, means of vehicular and pedestrian access, any car parking to be provided, and means of landscaping."

1.1.3 These Drawings are also being submitted under Regulation 5(4) of the 2009 Regulations which states:

"Where a plan comprises three or more separate sheets a key plan must be provided showing the relationship between the different sheets."

1.1.4 As these Drawings are part of the Application documentation, they should be read alongside and are informed by the other Application documents. In particular, the Drawings should be read alongside Schedule 1 of the draft Development Consent Order (**Application Document Reference: TR010031/APP/3.1**), the Engineering Section Drawings (**Application Document Reference: TR010031/APP/2.5**) and the General Arrangement Plan (**Application Document Reference: TR010031/APP/2.6**).




2 SCHEDULE OF PLANS INCLUDED IN THIS APPLICATION DOCUMENT



Document Title	Document Number	Revision
Structures Engineering Drawings and Sections – Regulation 5(2)(o) & 5(4) - Key Plan	TR010031/APP/2.7(A)	Rev 1
Structures Engineering Drawings and Sections - Regulation 5(2)(o) Kingsway Viaduct (Junction 67) - Sheet 1 of 13	TR010031/APP/2.7(B)	Rev 1
Structures Engineering Drawings and Sections - Regulation 5(2)(o) Kingsway Viaduct (Junction 67) - Sheet 2 of 13	TR010031/APP/2.7(C)	Rev 1
Structures Engineering Drawings and Sections - Regulation 5(2)(o) Allerdene Bridge (Embankment Option) - Sheet 3 of 13	TR010031/APP/2.7(D)	Rev 1
Structures Engineering Drawings and Sections - Regulation 5(2)(o) Allerdene Bridge (6 Span Viaduct Option) - Sheet 4 of 13	TR010031/APP/2.7(E)	Rev 1
Structures Engineering Drawings and Sections - Regulation 5(2)(o) Allerdene Bridge (7 Span Viaduct Option) - Sheet 5 of 13	TR010031/APP/2.7(F)	Rev 1
Structures Engineering Drawings and Sections - Regulation 5(2)(o) Eighton Lodge Slip Road Underbridge - Sheet 6 of 13	TR010031/APP/2.7(G)	Rev 1
Structures Engineering Drawings and Sections - Regulation 5(2)(o) Eighton Lodge North Underbridge - Sheet 7 of 13	TR010031/APP/2.7(H)	Rev 1
Structures Engineering Drawings and Sections - Regulation 5(2)(o) Eighton Lodge South Underbridge -	TR010031/APP/2.7(I)	Rev 1

Sheet 8 of 13		
Structures Engineering Drawings and Sections - Regulation 5(2)(o) Longbank Underpass - Sheet 9 of 13	TR010031/APP/2.7(J)	Rev 1
Structures Engineering Drawings and Sections - Regulation 5(2)(o) North Dene Footbridge - Sheet 10 of 13	TR010031/APP/2.7(K)	Rev 1
Structures Engineering Drawings and Sections - Regulation 5(2)(o) North Dene Footbridge - Sheet 11 of 13	TR010031/APP/2.7(L)	Rev 1
Structures Engineering Drawings and Sections - Regulation 5(2)(o) Typical ADS Gantry – Truss Cantilever Type - Sheet 12 of 13	TR010031/APP/2.7(M)	Rev 1
Structures Engineering Drawings and Sections - Regulation 5(2)(o) Typical ADS Gantry Portal Type - Sheet 13 of 13	TR010031/APP/2.7(N)	Rev 1

NOTES:
 1. NO DETAILS HAVE BEEN PROVIDED NORTH OF JUNCTION 76 (COAL HOUSE) AS THE CARRIAGEWAY IS NOT BEING AMENDED.

KEY

-  ORDER LIMITS
-  LOCAL AUTHORITY BOUNDARY
-  INDICATIVE SCHEME (SHOWN FOR ILLUSTRATIVE PURPOSES ONLY)

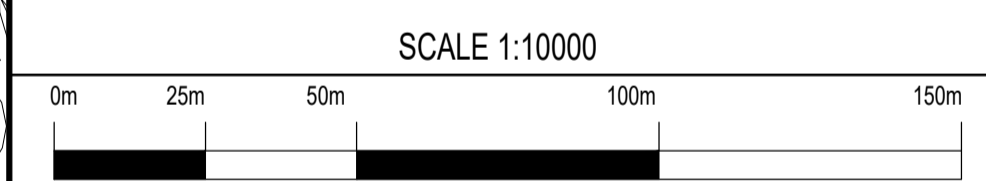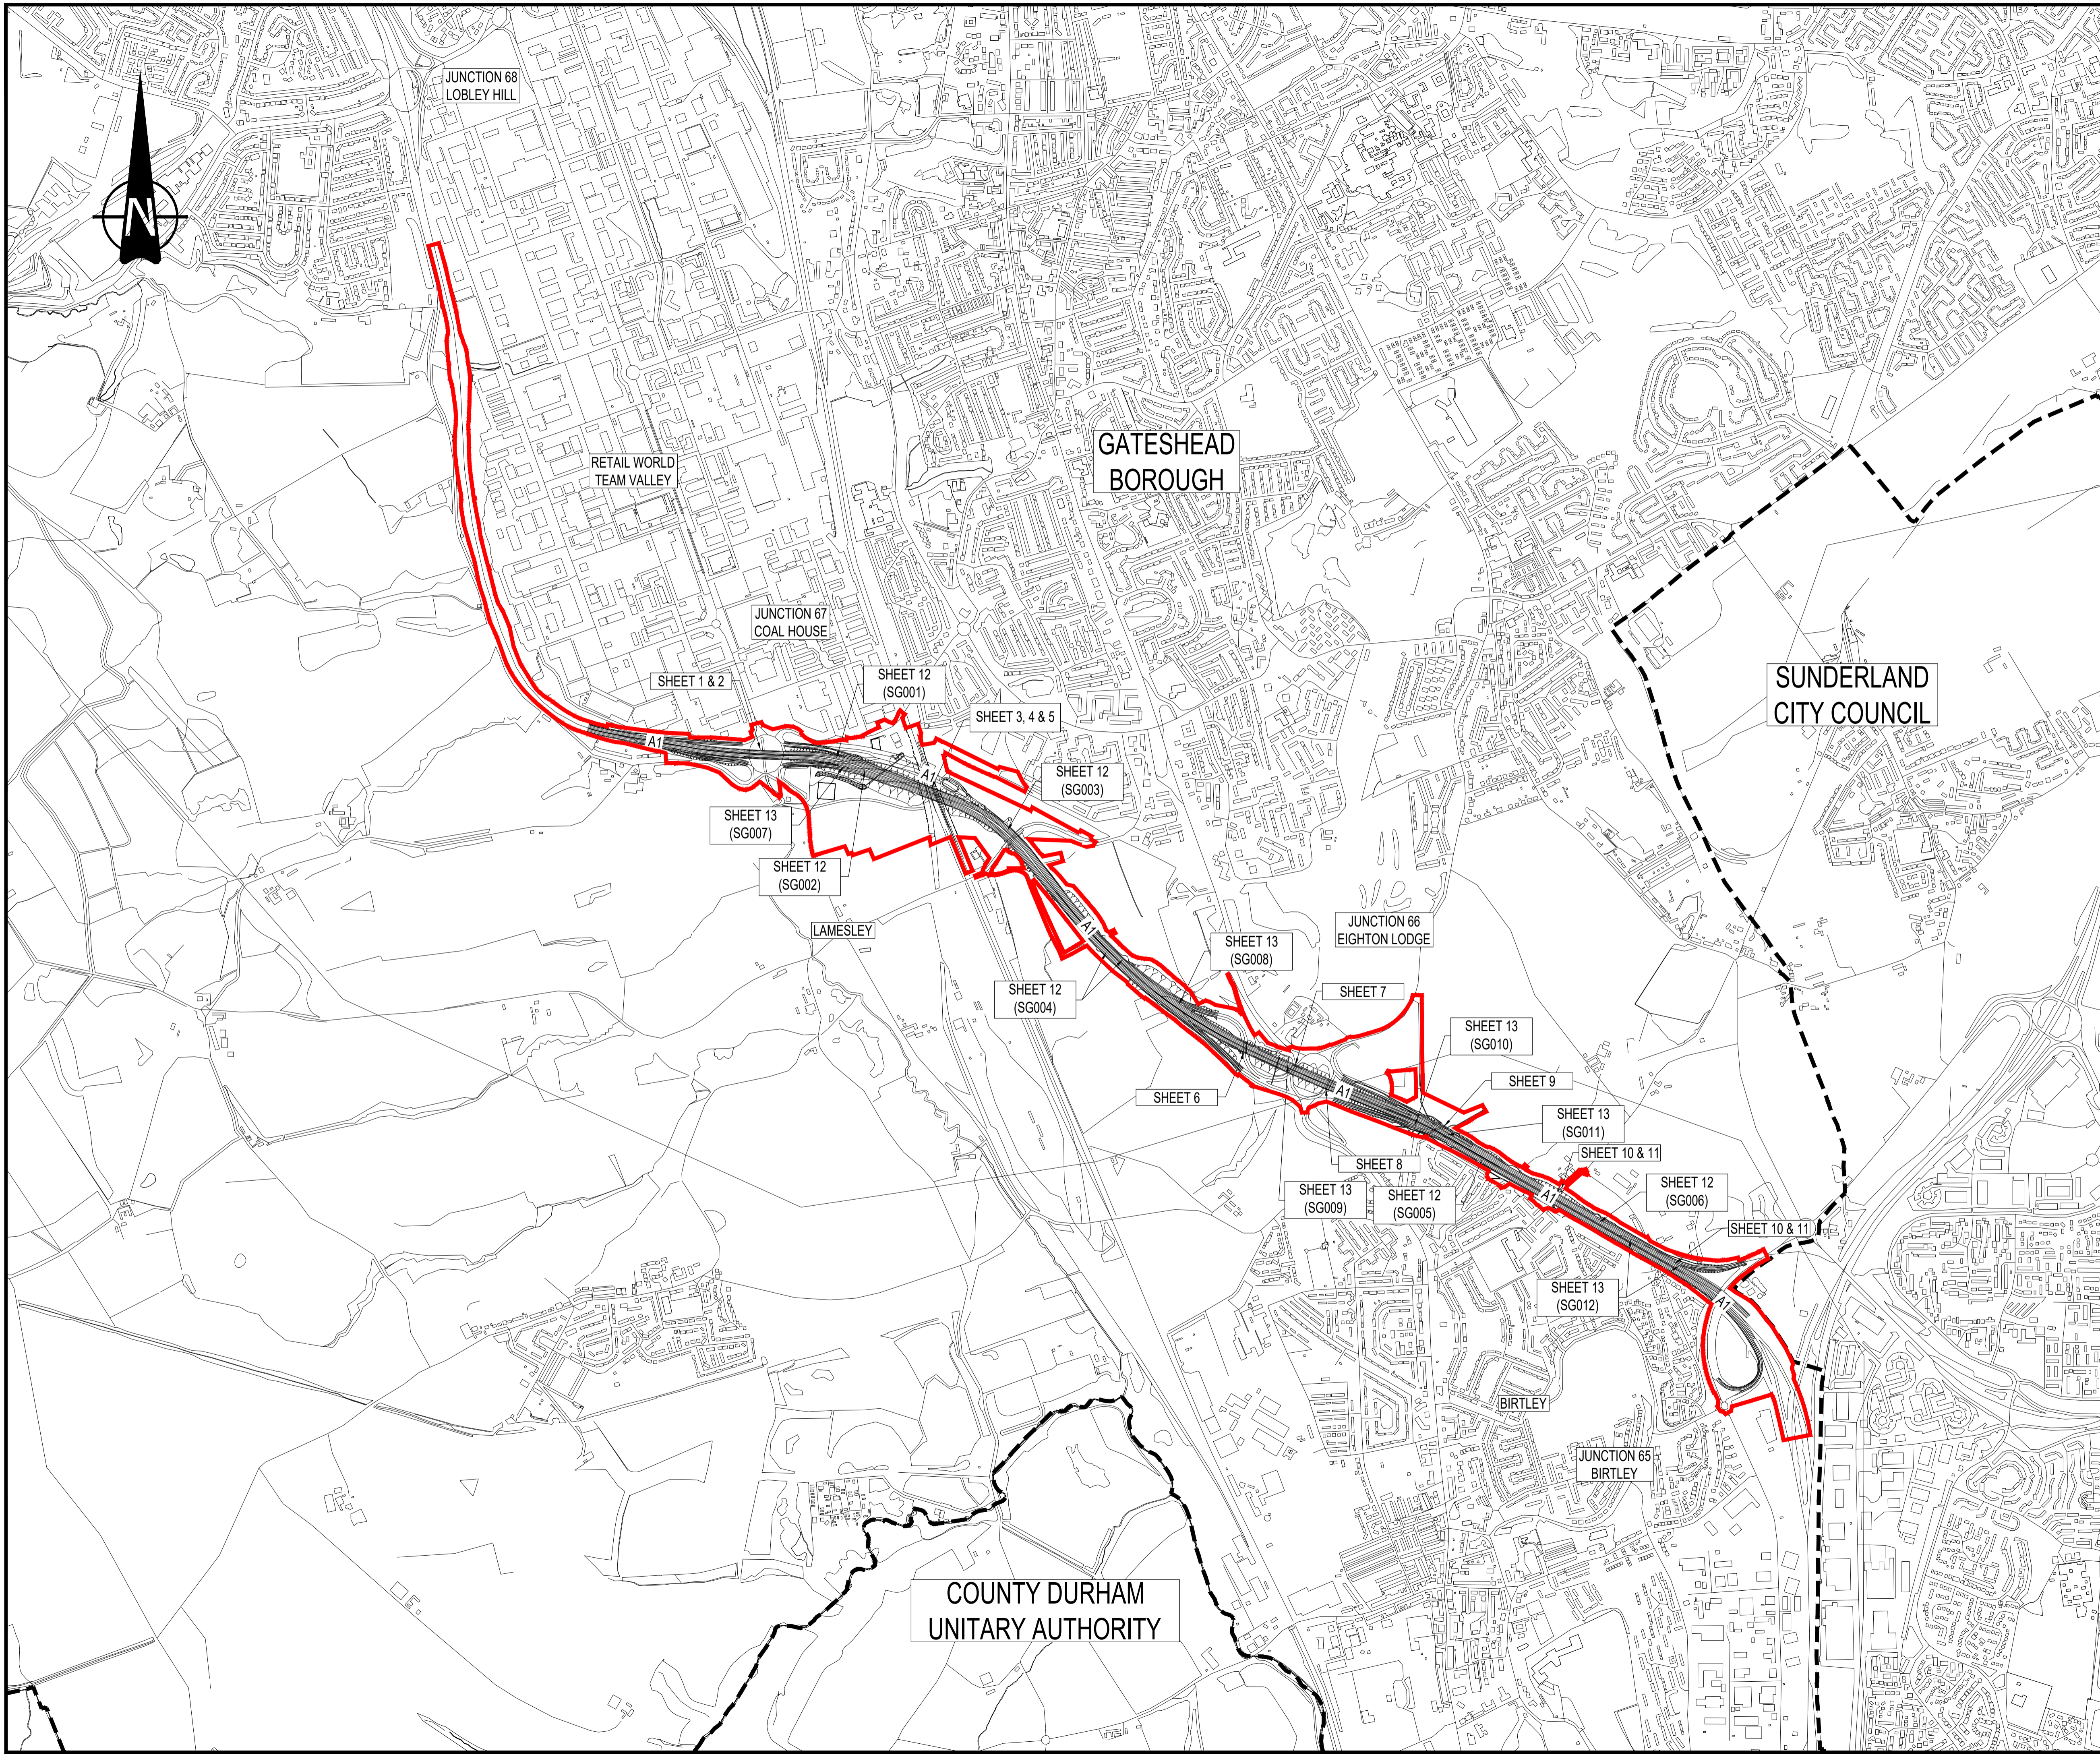

Rev.	Date	Description	By	Eng' Chk	Disc' Chk	App'd	Status
1	25/02/20	For Examination Deadline 2					RA IA IA NR
0	27/09/19	For Application					RA IA IA NR

For Examination Deadline 2 A3

PINS Reference Number **TR010031/APP/2.7(A)**

Client




Project Title **A1 BIRTLEY TO COAL HOUSE**

Drawing Title **STRUCTURES ENGINEERING DRAWINGS & SECTIONS REGULATION 5(4) KEY PLAN**


Scale	Drawn	Eng. Check	Approved	Authorised
N/A	R.Ayre	I.Akram	I.Akram	N.Rawcliffe
Original Size	Date	Date	Date	Date
A1	25/02/20	25/02/20	25/02/20	25/02/20
Drawing Number	Originator	Volume	Revision	
HE551462	WSP	LSI	1	
Section	Type	Role	Number	
ZZ	DR	ZL	45023	
			3	

NOTES:

1. ALL DIMENSION ARE IN MILLIMETRES UNLESS NOTED OTHERWISE.
2. ALL LEVELS AND CHAINAGES ARE IN METRES UNLESS NOTED OTHERWISE.
3. DO NOT SCALE. IN CASE OF DOUBTS, OMISSIONS OR ERRORS SEEK CLARIFICATION FROM THE DESIGNER.

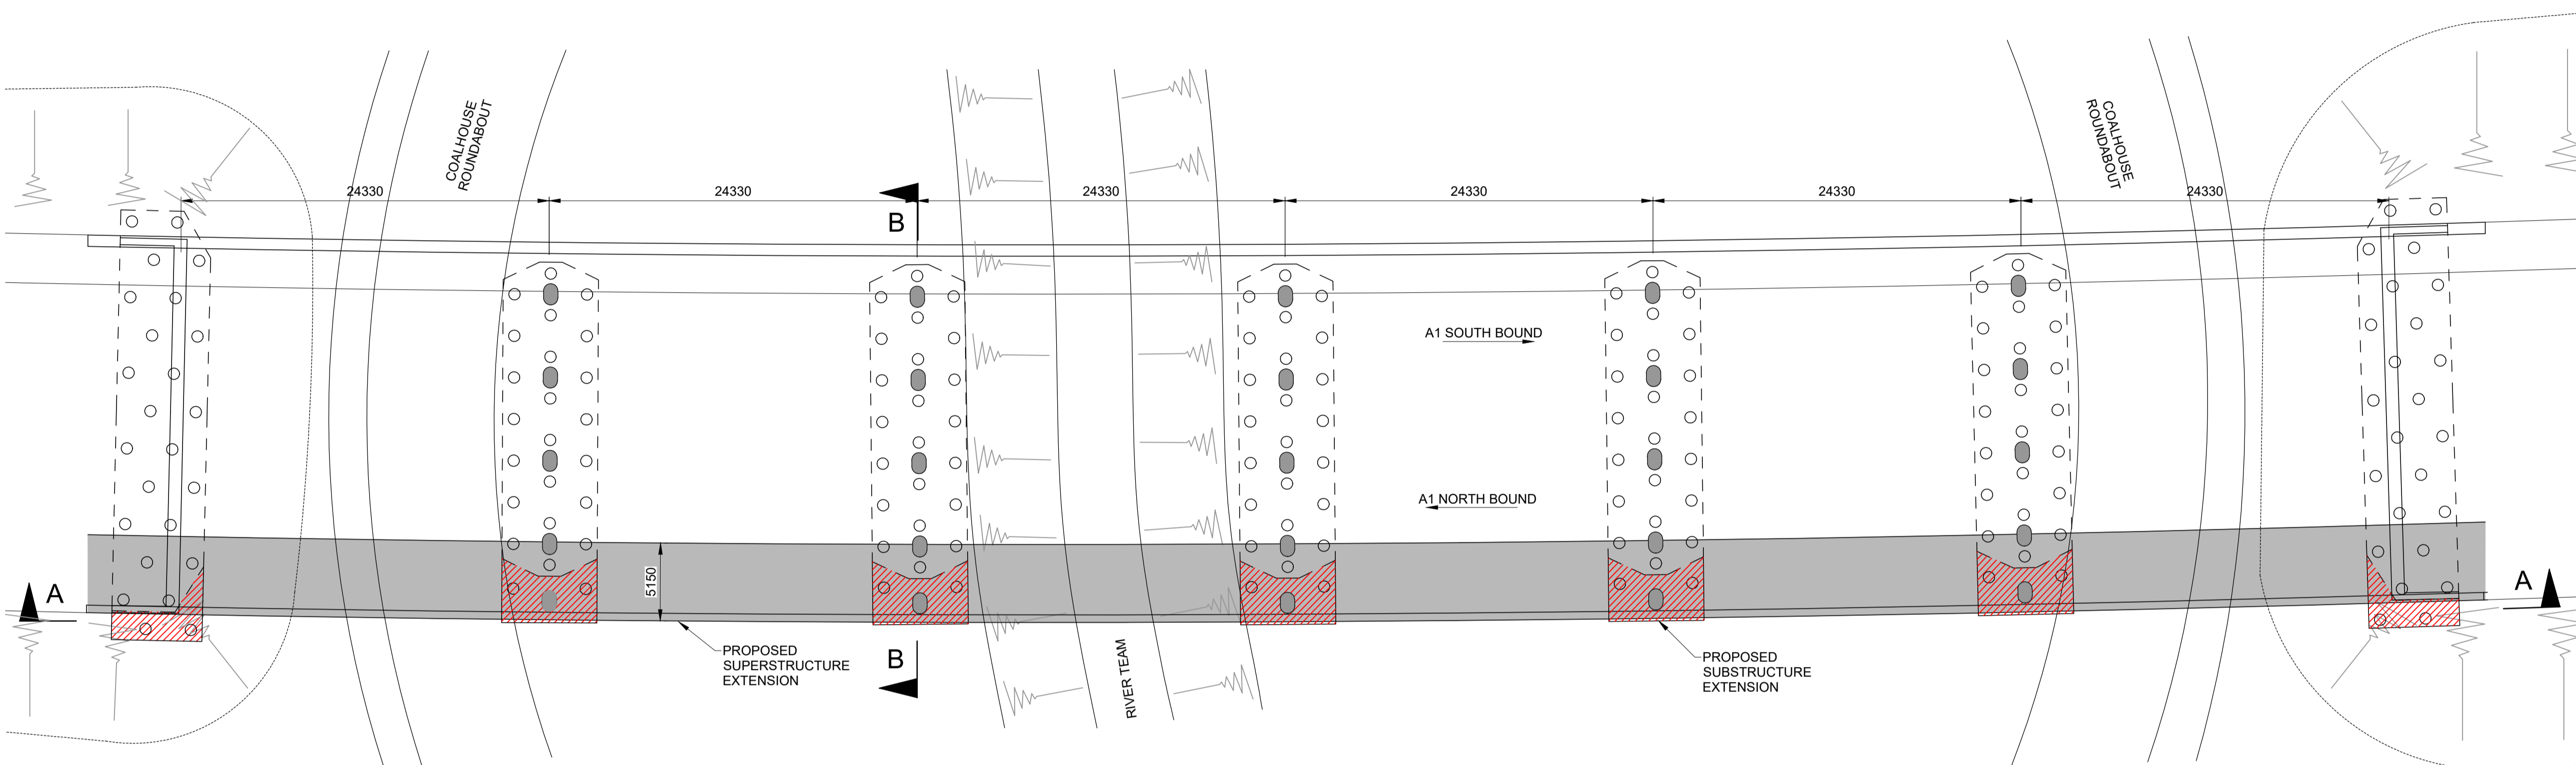

KINGSWAY VIADUCT (JUNCTION 67)
DECK PLAN
SCALE 1:250

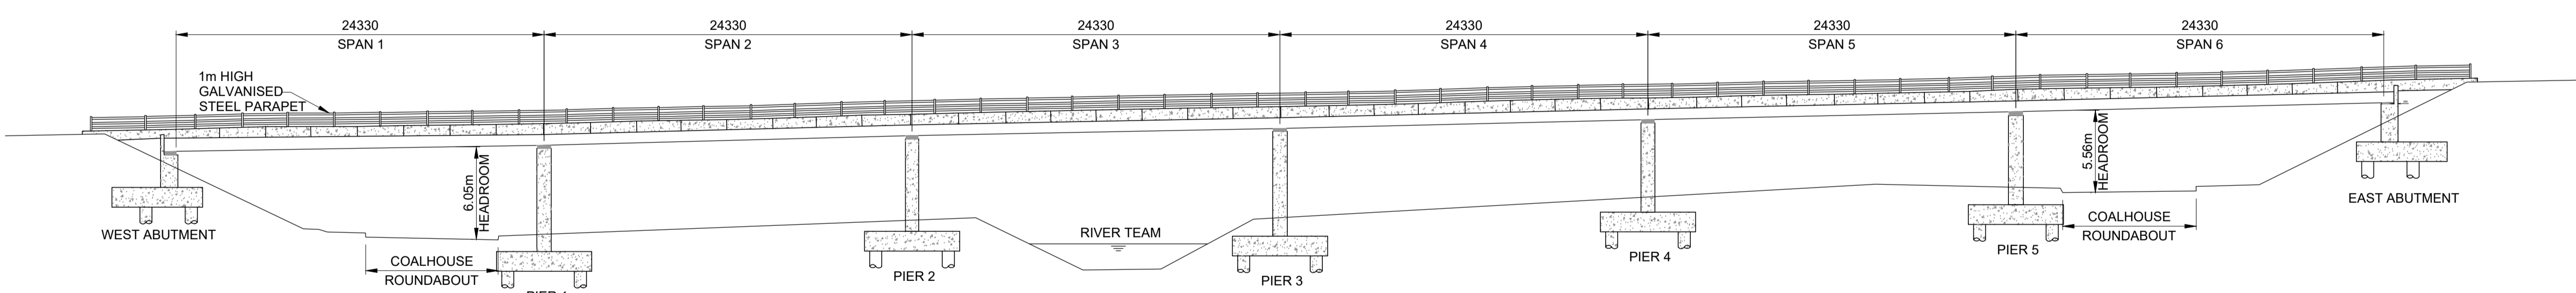

KINGSWAY VIADUCT (JUNCTION 67)
TYPICAL LONGITUDINAL SECTION A-A
SCALE 1:250

SCALE 1:250 0 2500 5000

Rev.	Date	Description	By	Eng' Chk	Disc' Chk	App'd	Status
1	25/02/20	For Examination Deadline 2		RA	IA	IA	NR
0	27/09/19	For Application		RA	IA	IA	NR

Suitability	For Examination Deadline 2	Status	A3
-------------	----------------------------	--------	----

PINS Reference Number TR010031/APP/2.7(B)



Client
A1 BIRTLEY TO COAL HOUSE

Drawing Title
STRUCTURES ENGINEERING DRAWINGS & SECTIONS REGULATION 5(2)(o)
KINGSWAY VIADUCT (JUNCTION 67)
(SHEET 1 OF 14)


Scale	Drawn	Eng. Check	Approved	Authorised
N/A	R.Ayre	I.Akram	I.Akram	N.Rawcliffe
Original Size	Date	Date	Date	Date
A1	25/02/20	25/02/20	25/02/20	25/02/20

Drawing Number	Originator	Volume	Revision
HE551462	WSP	LSI	1
Section	Type	Role	Number
ZZ	DR	ZL	45010


Confidential

NOTES:

1. ALL DIMENSION ARE IN MILLIMETRES UNLESS NOTED OTHERWISE.
2. ALL LEVELS AND CHAINAGES ARE IN METRES UNLESS NOTED OTHERWISE.
3. DO NOT SCALE. IN CASE OF DOUBTS, OMISSIONS OR ERRORS SEEK CLARIFICATION FROM THE DESIGNER.

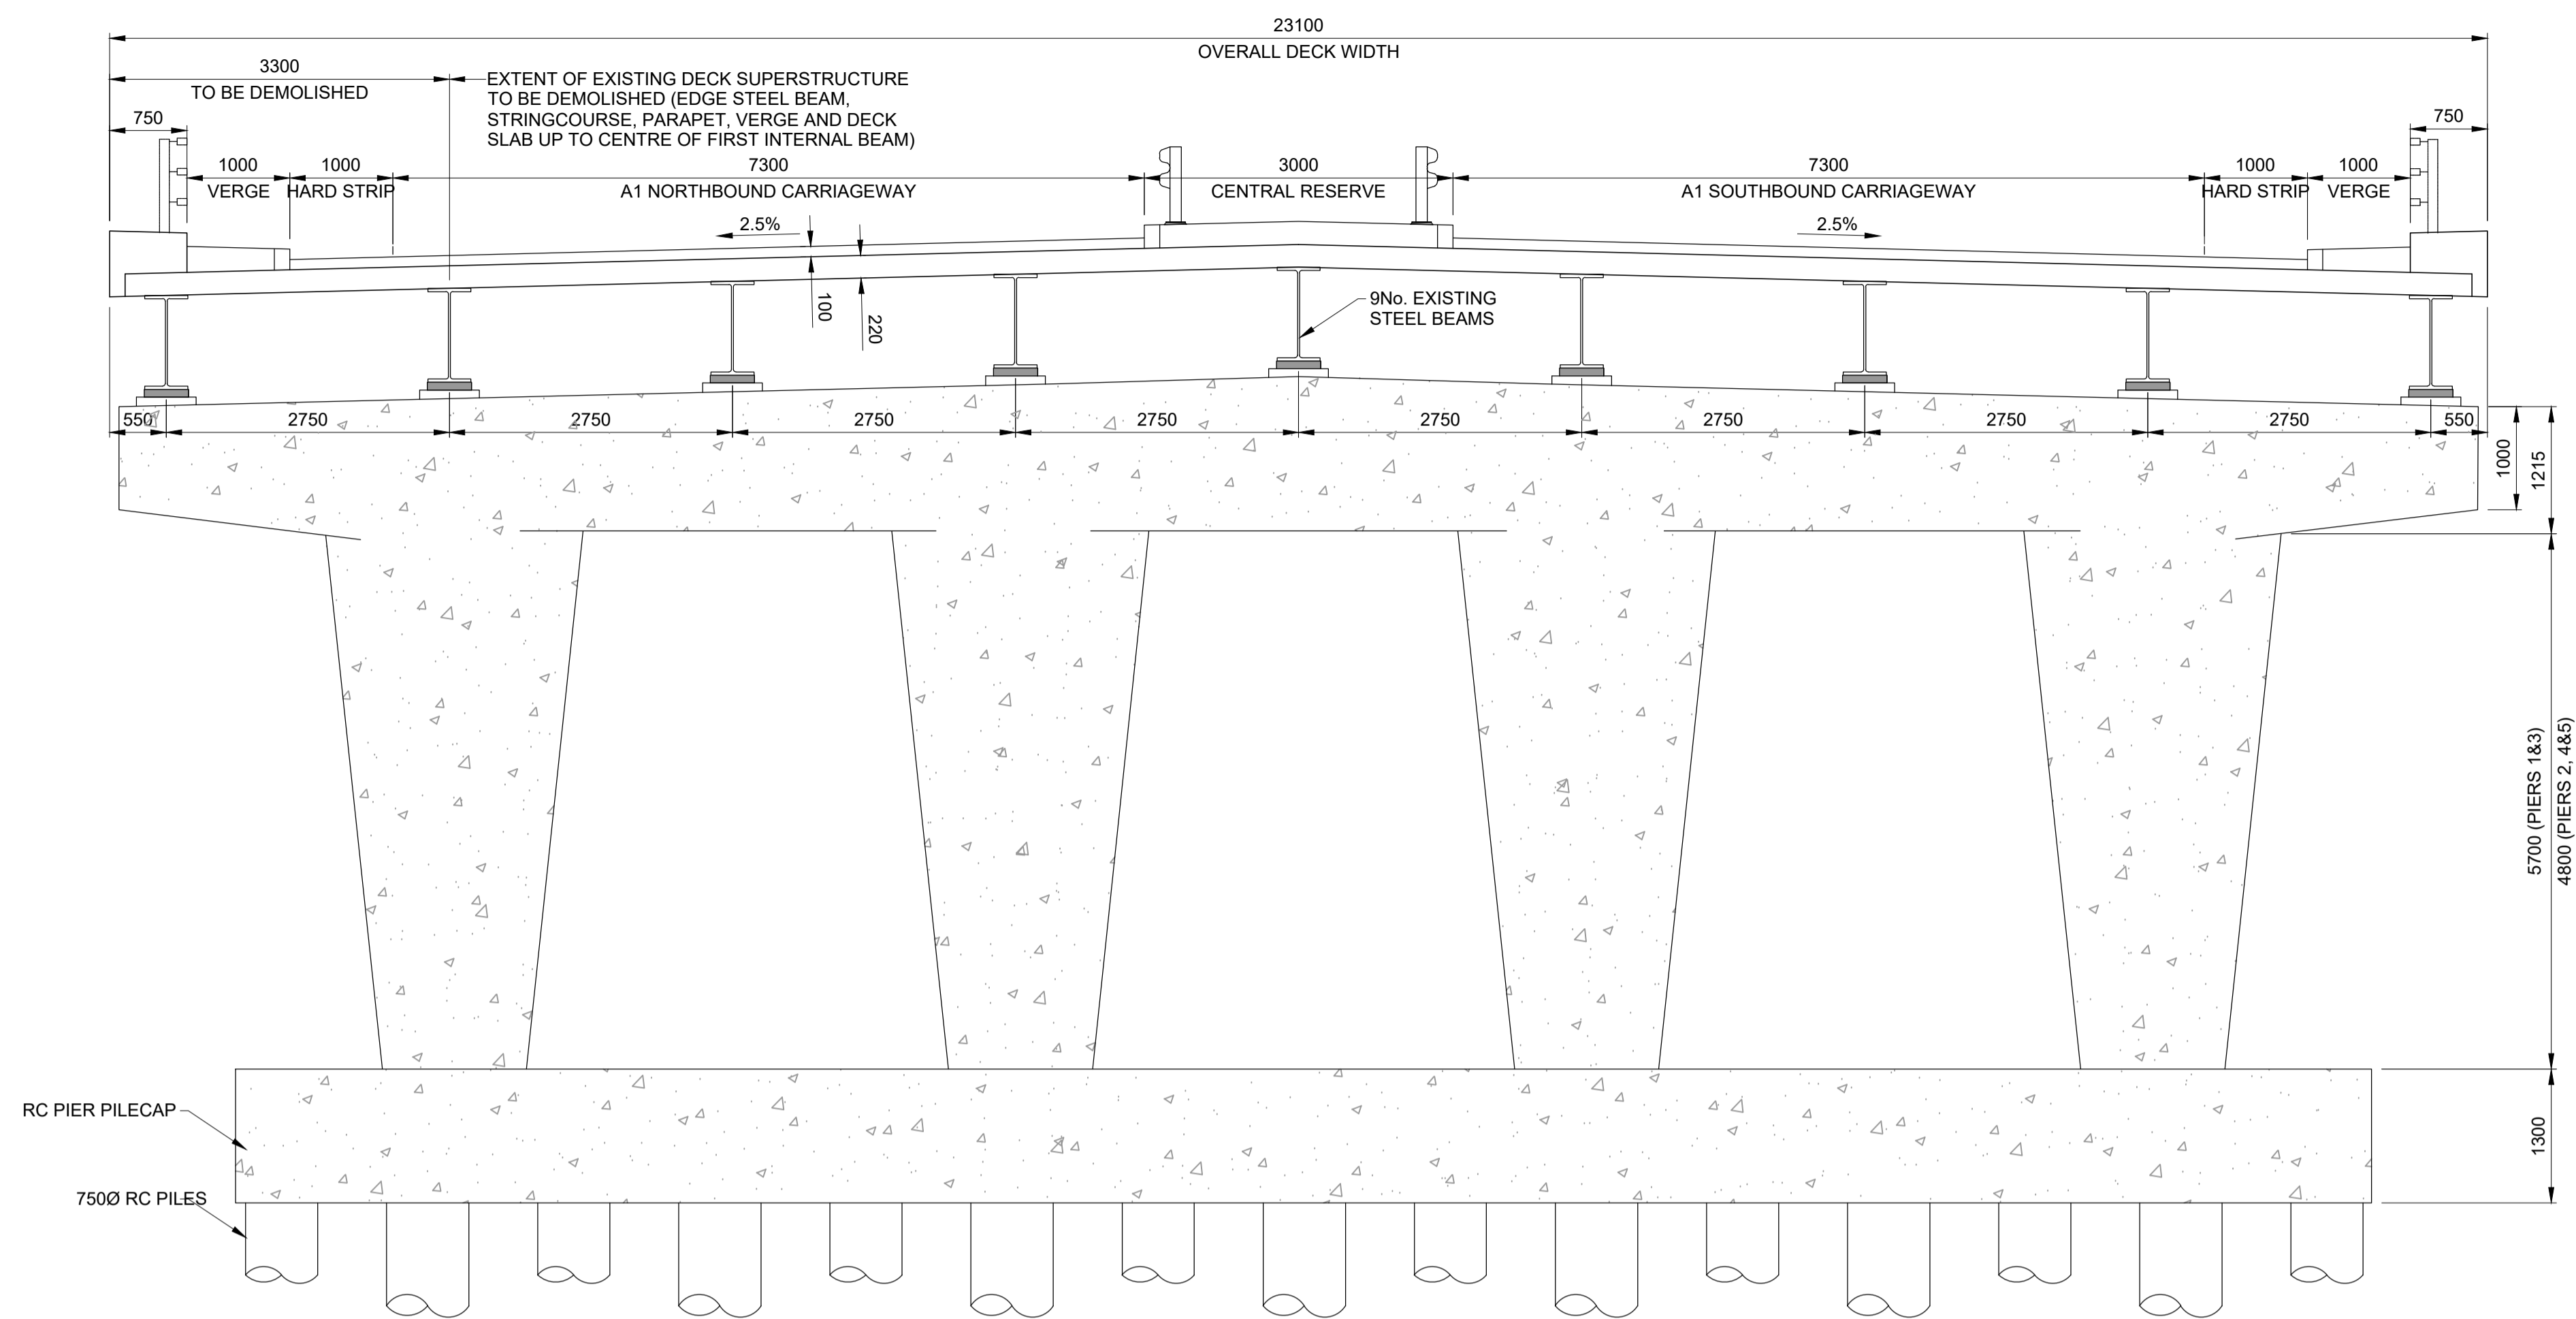

KINGSWAY VIADUCT (JUNCTION 67)
EXISTING CROSS SECTION B-B
SCALE 1:50

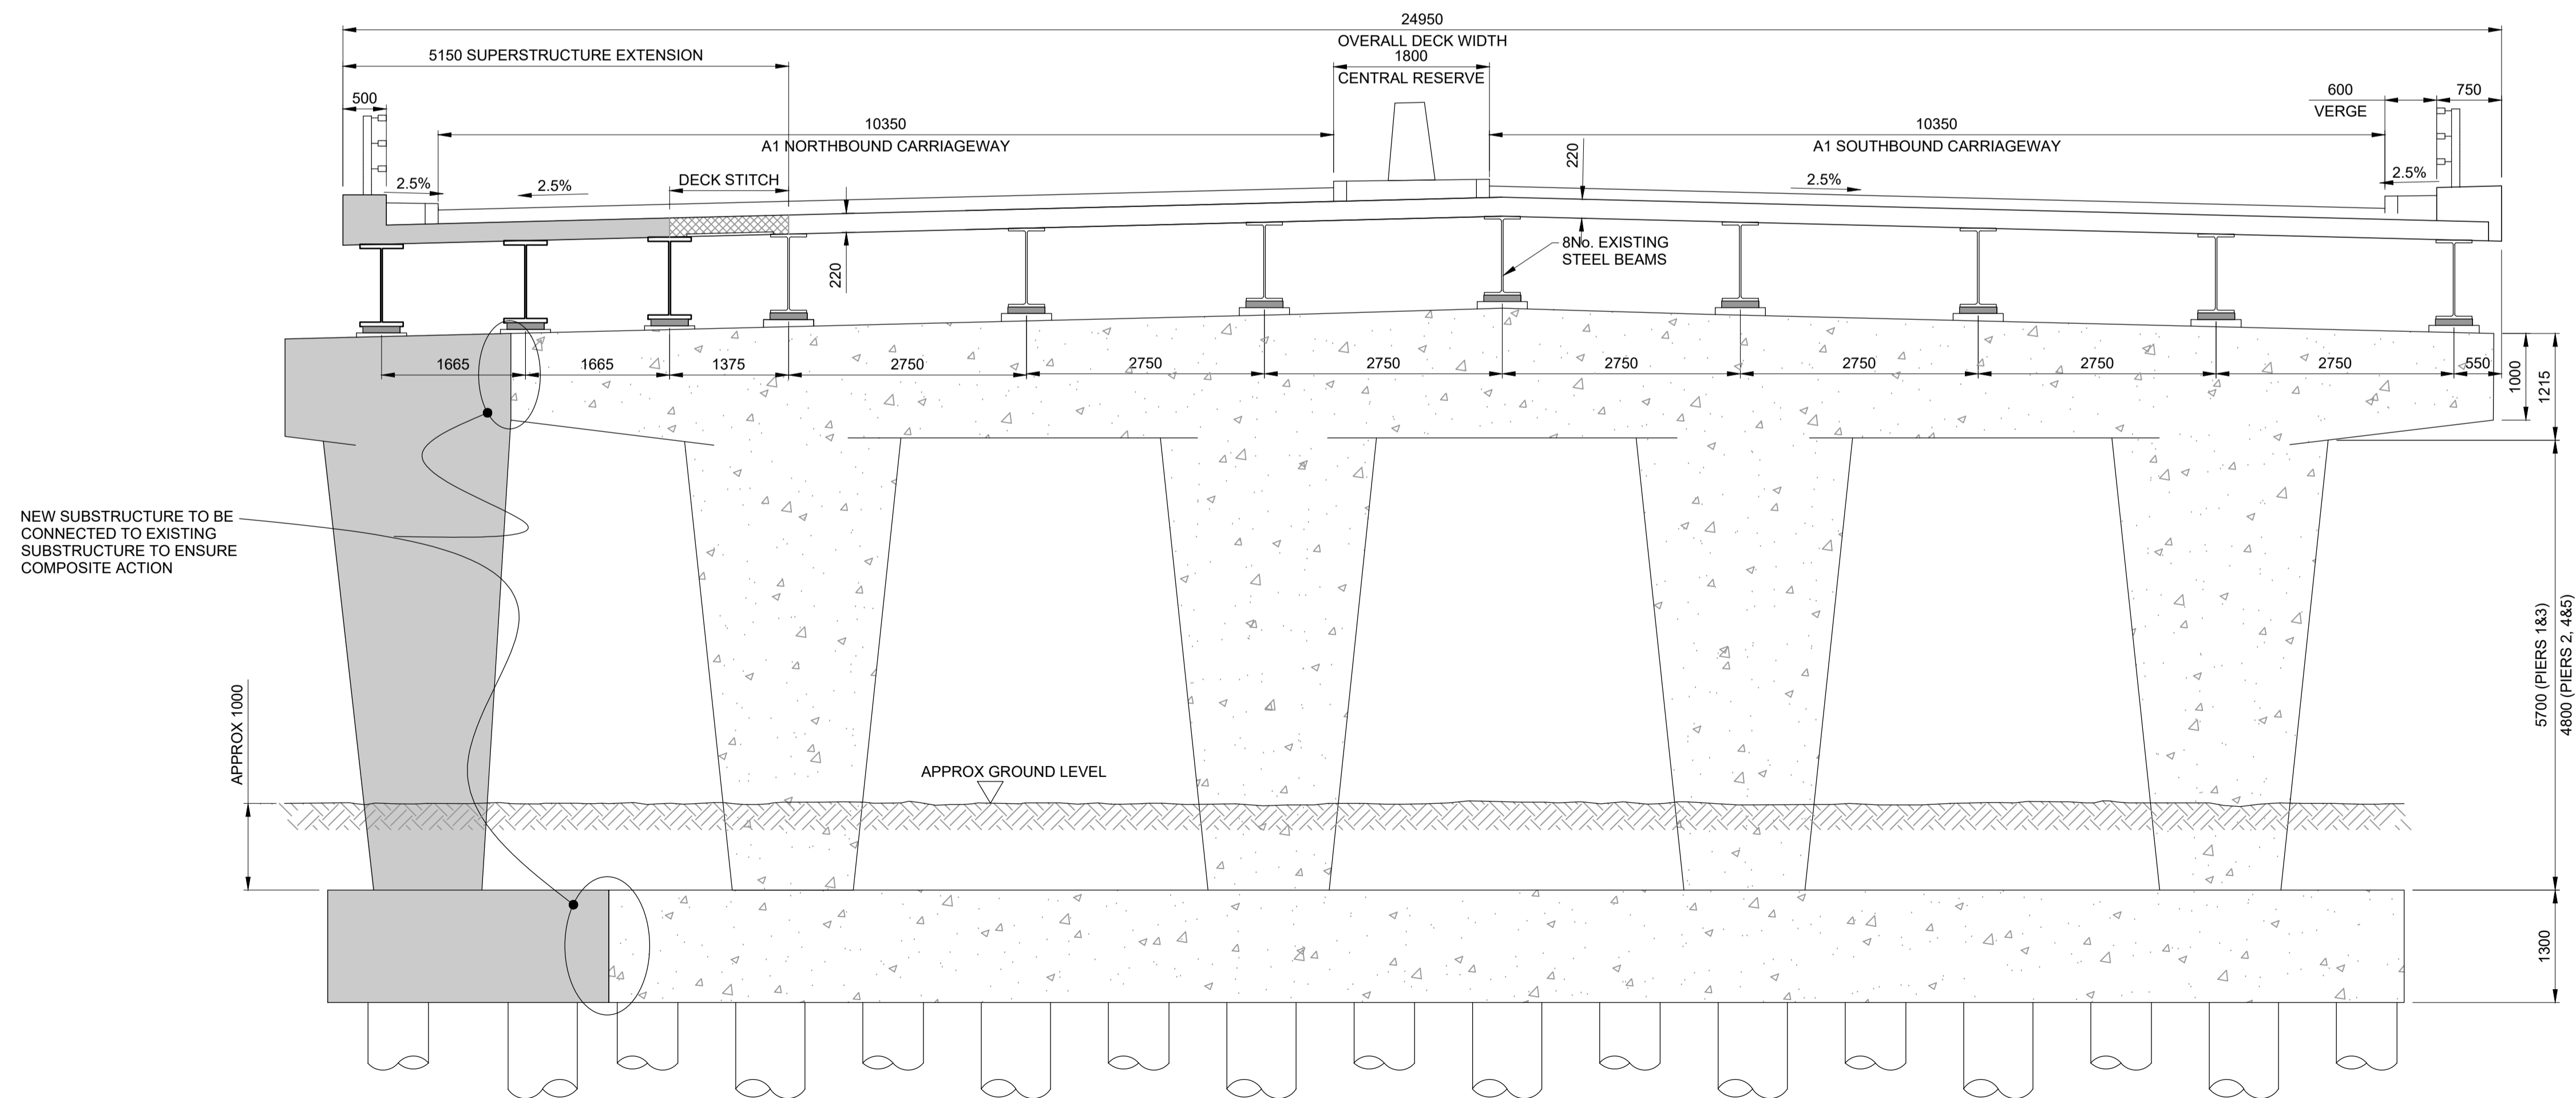

KINGSWAY VIADUCT (JUNCTION 67)
PROPOSED CROSS SECTION B-B
SCALE 1:50

SCALE 1:50 0 500 1000

Rev.	Date	Description	By	Eng' Chk	Disc' Chk	App'd	Status
1	25/02/20	For Examination Deadline 2		RA	IA	IA	NR
0	27/09/19	For Application		RA	IA	IA	NR

For Examination Deadline 2

A3

PINS Reference Number

TR010031/APP/2.7(C)

Client



Project Title

A1 BIRTLEY TO COAL HOUSE

Drawing Title

STRUCTURES ENGINEERING DRAWINGS
& SECTIONS REGULATION 5(2)(o)
KINGSWAY VIADUCT (JUNCTION 67)
(SHEET 2 OF 14)


Scale	Drawn	Eng. Check	Approved	Authorised
N/A	R.Ayre	I.Akram	I.Akram	N.Rawcliffe
Original Size	Date	Date	Date	Date
A1	25/02/20	25/02/20	25/02/20	25/02/20

Drawing Number	Originator	Volume	Revision
HE551462	WSP	LSI	1
Section	Type	Role	Number
ZZ	DR	ZL	45011
			3


- NOTES:**
1. ALL DIMENSION ARE IN MILLIMETRES UNLESS NOTED OTHERWISE.
 2. ALL LEVELS AND CHAINAGES ARE IN METRES UNLESS NOTED OTHERWISE.
 3. DO NOT SCALE. IN CASE OF DOUBTS, OMISSIONS OR ERRORS SEEK CLARIFICATION FROM THE DESIGNER.

KEY:


- EXISTING BRIDGE (TO BE DEMOLISHED)
- NEW BRIDGE
- EXISTING ALLERDENE CULVERT TO BE REMOVED AND REPLACED WITH OPEN DITCH
- PROPOSED ALLERDENE CULVERT STRUCTURE
- PROPOSED OPEN DRAINAGE DITCH

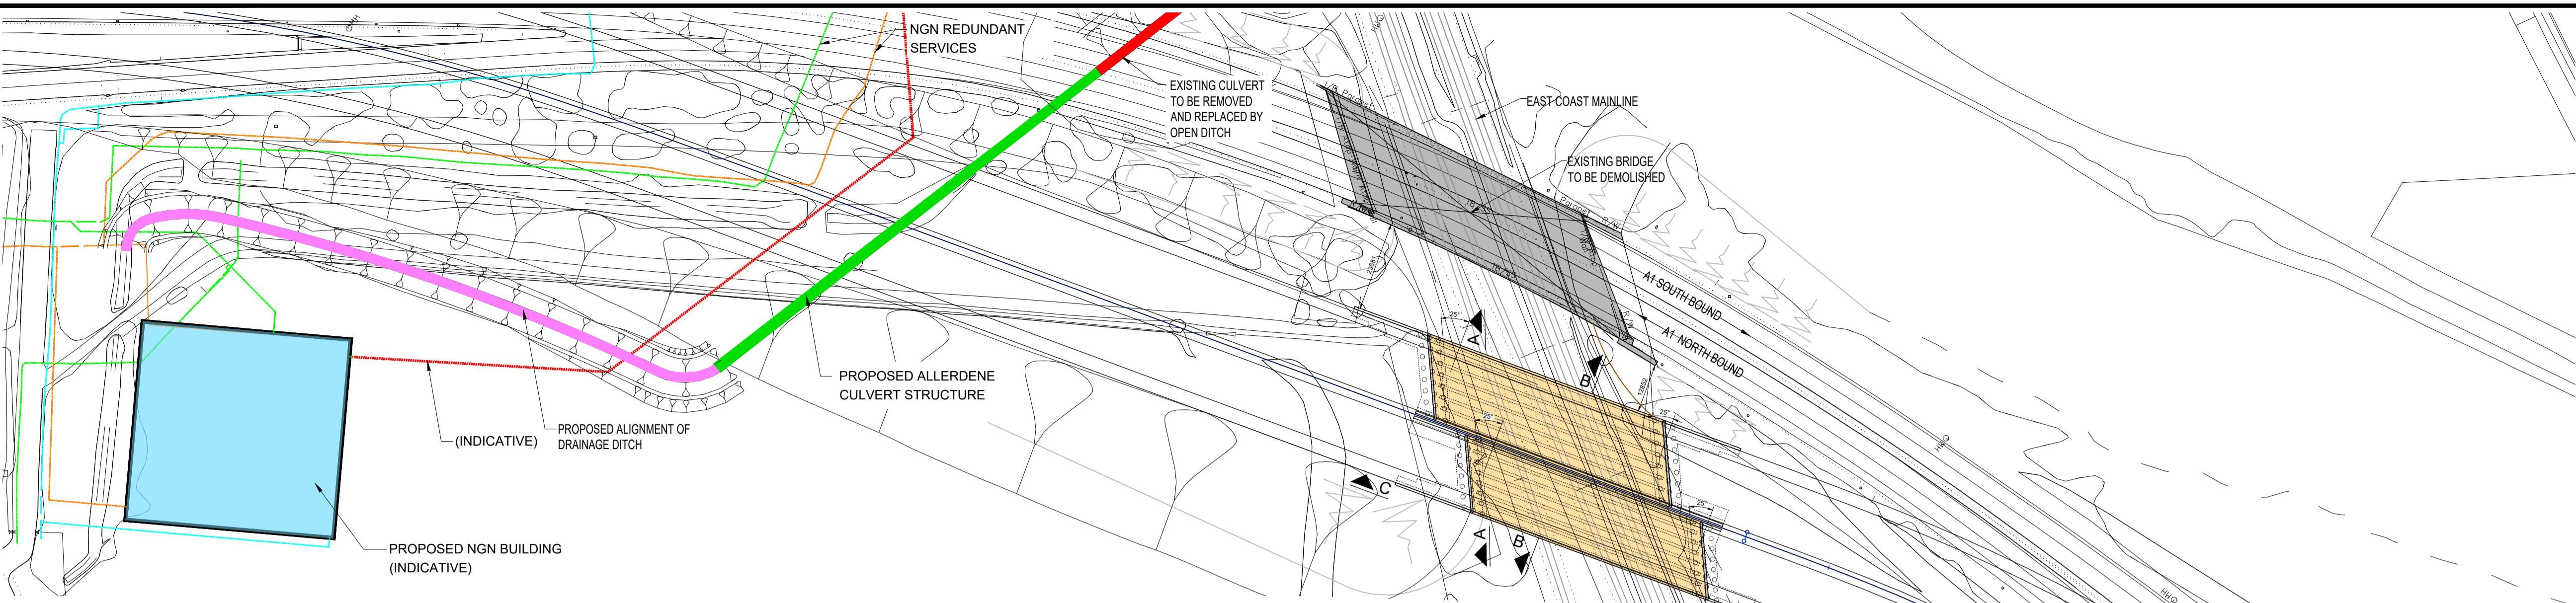


**ALLERDENE BRIDGE (EMBANKMENT OPTION)
PLAN
SCALE 1:1000**

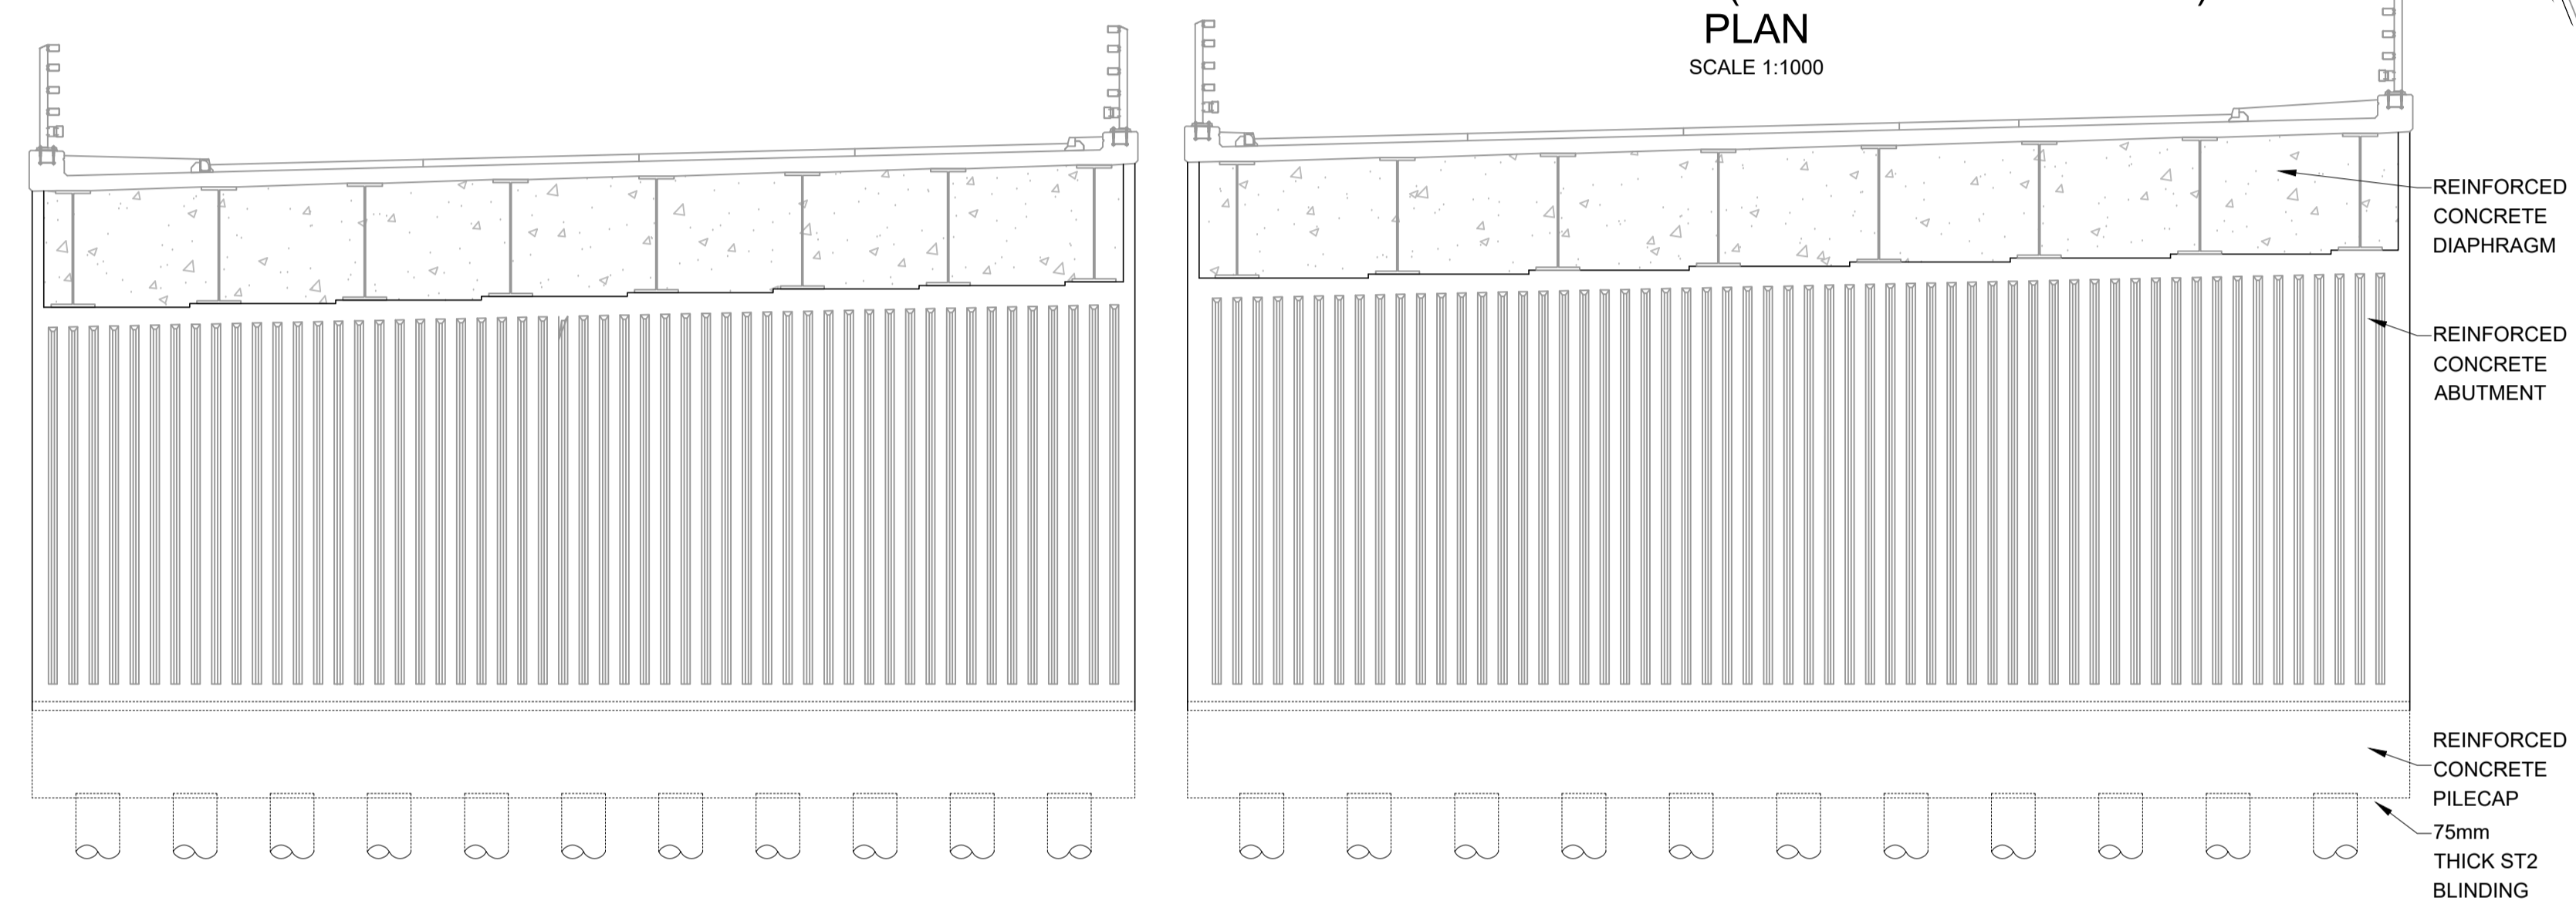

**ALLERDENE BRIDGE (EMBANKMENT OPTION)
TYPICAL ABUTMENT ELEVATION A-A
SCALE 1:100**

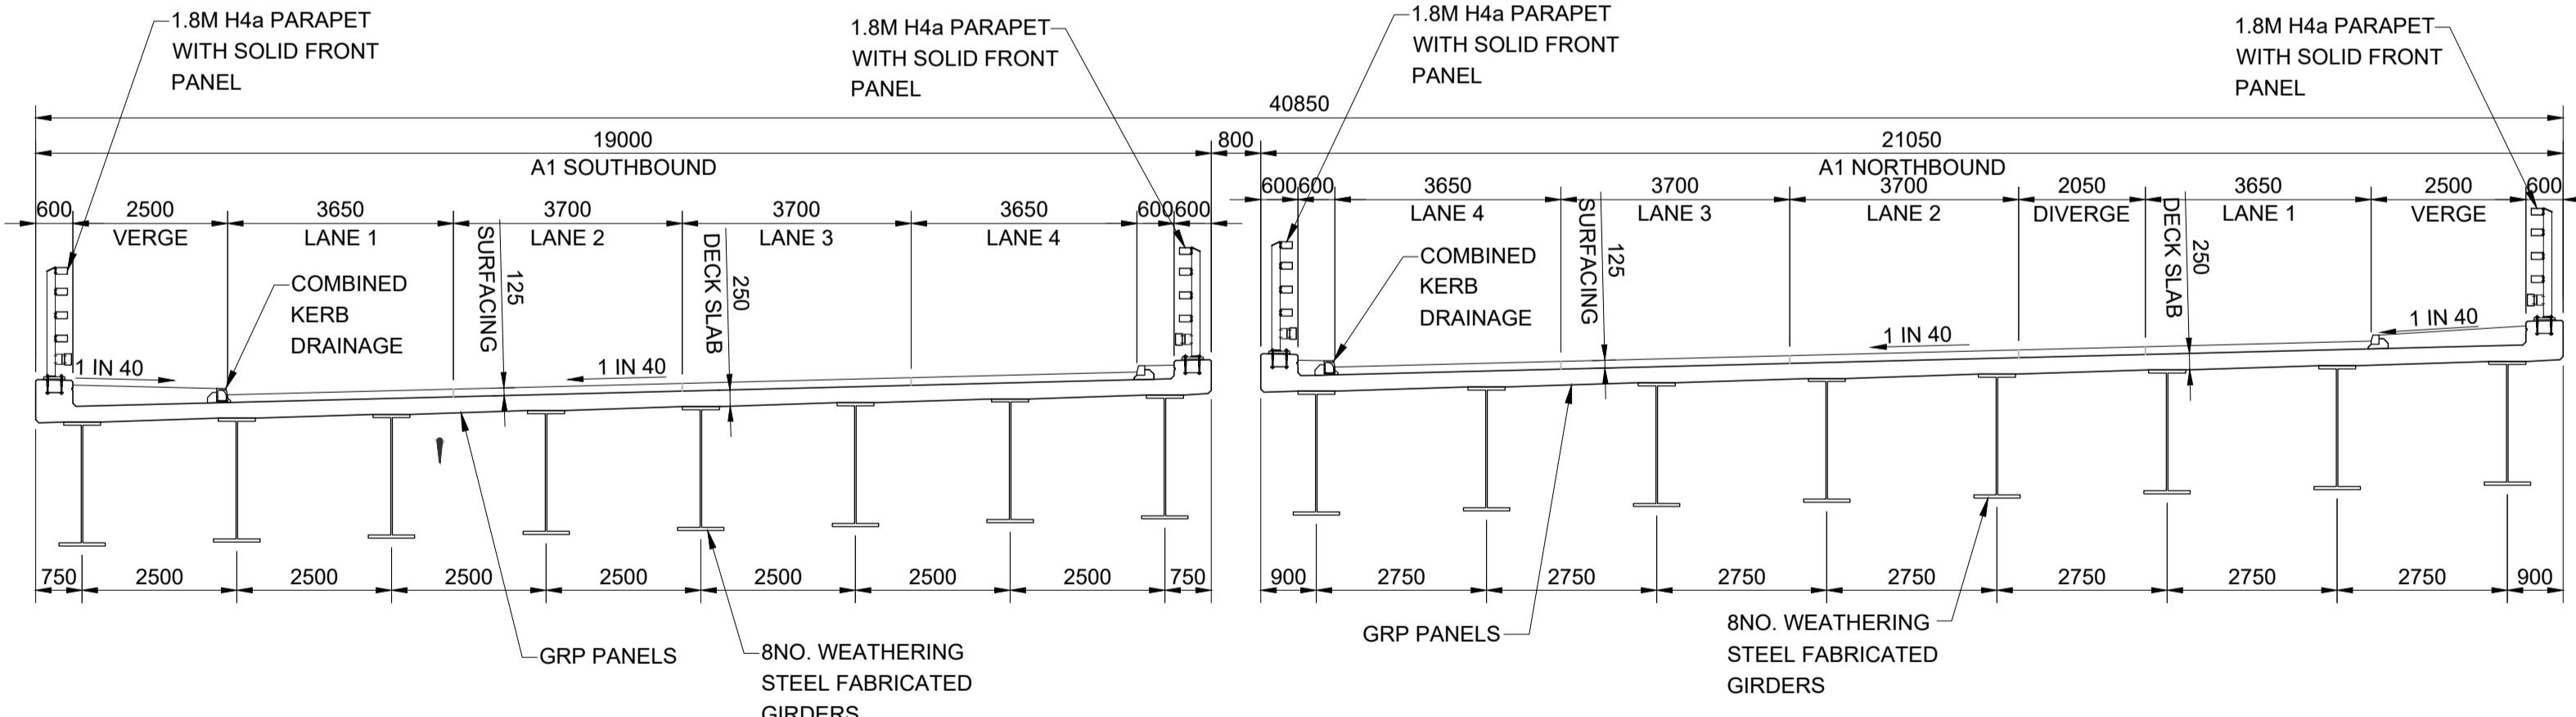

**ALLERDENE BRIDGE (EMBANKMENT OPTION)
SECTION B-B
SCALE 1:100**

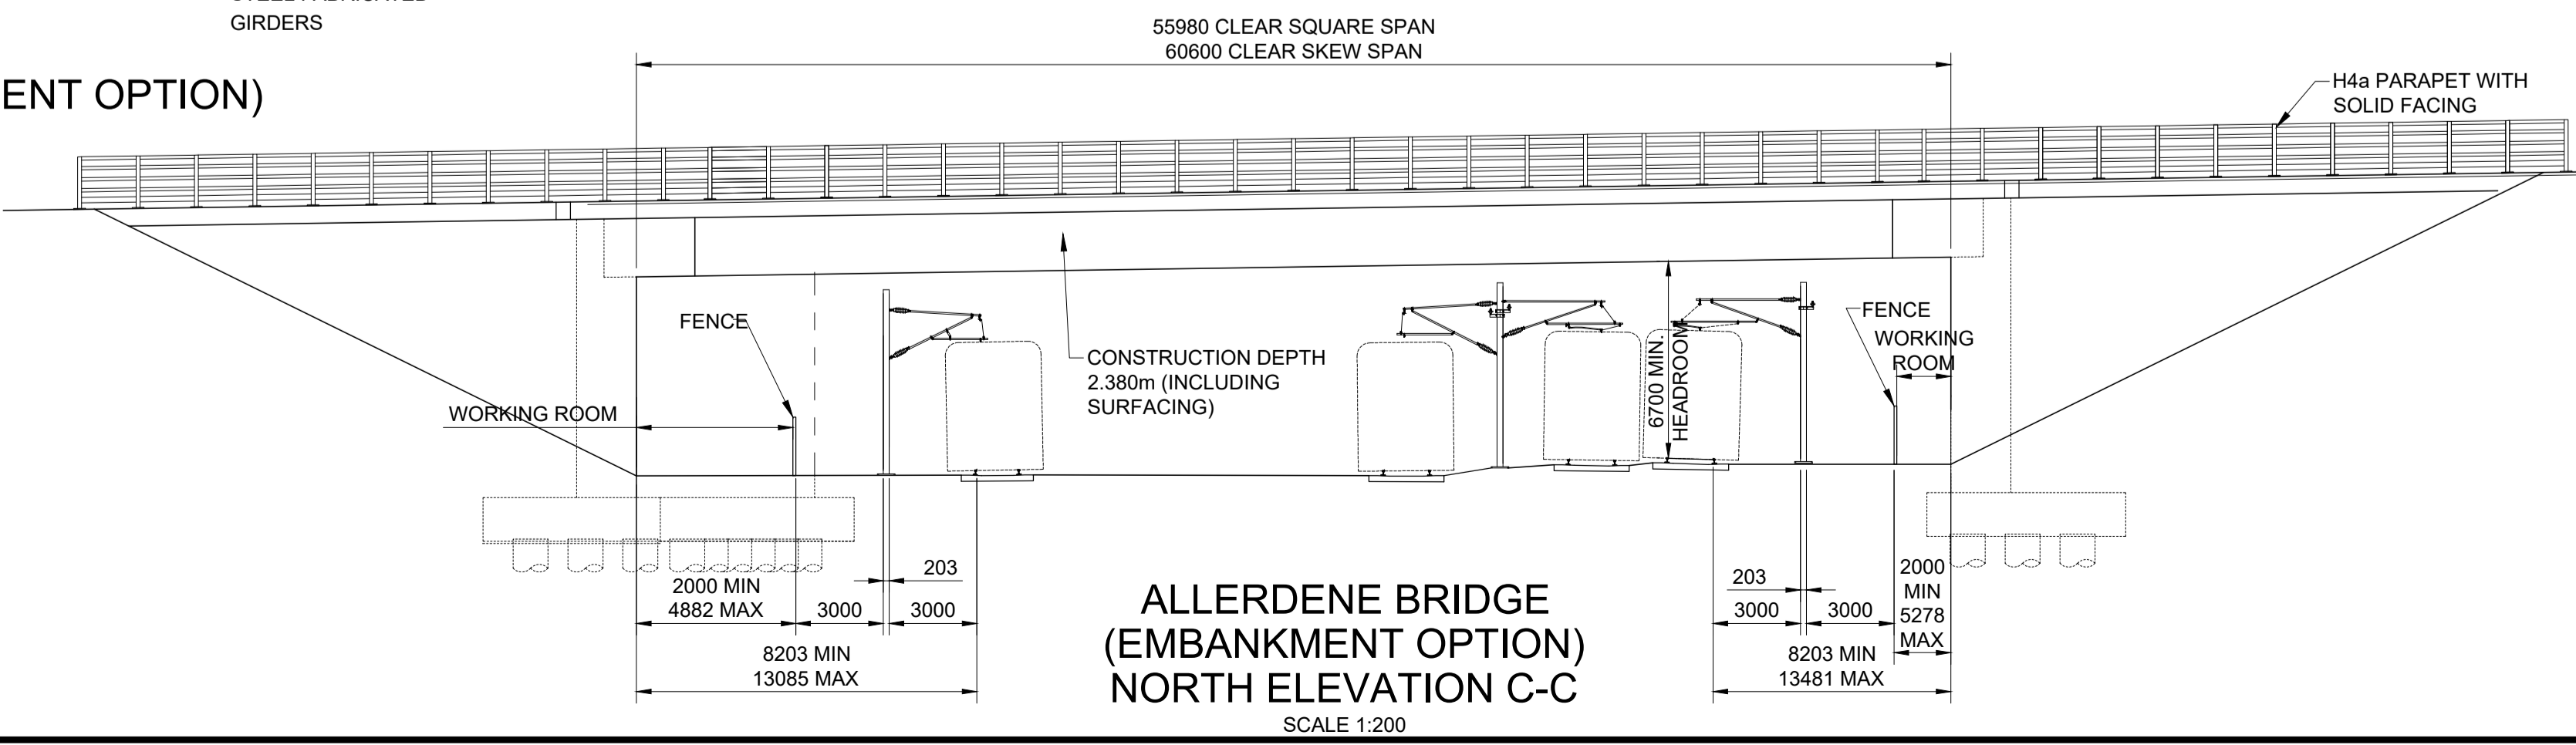

**ALLERDENE BRIDGE (EMBANKMENT OPTION)
NORTH ELEVATION C-C
SCALE 1:200**

SCALE 1:100 0 1000 2000

SCALE 1:200 0 2000 2500

SCALE 1:1000 0 10000 20000

Rev.	Date	Description	By	Eng' Chk	Disc' Chk	App'd
1	25/02/20	For Examination Deadline 2		RA	IA	IA NR
0	27/09/19	For Application		RA	IA	IA NR

Suitability: For Examination Deadline 2
Status: A3

TR010031/APP/2.7(D)



A1 BIRTLEY TO COAL HOUSE

**STRUCTURES ENGINEERING DRAWINGS & SECTIONS REGULATION 5(2)(o)
ALLERDENE BRIDGE (EMBANKMENT OPTION)
(SHEET 3 OF 14)**



Scale	Drawn	Eng. Check	Approved	Authorised
N/A	R.Ayre	I.Akram	I.Akram	N.Rawcliffe

Original Size	Date	Date	Date	Date
A1	25/02/20	25/02/20	25/02/20	25/02/20


Drawing Number	Originator	Volume	Revision
HE551462	WSP	LSI	1

Section	Type	ID	Direction	Type	Role	Number
ZZ	DR	ZL	45012			3


- NOTES:**
- ALL DIMENSIONS ARE IN MILLIMETRES UNLESS NOTED OTHERWISE.
 - ALL LEVELS AND CHAINAGES ARE IN METRES UNLESS NOTED OTHERWISE.
 - DO NOT SCALE. IN CASE OF DOUBTS, OMISSIONS OR ERRORS SEEK CLARIFICATION FROM THE DESIGNER.

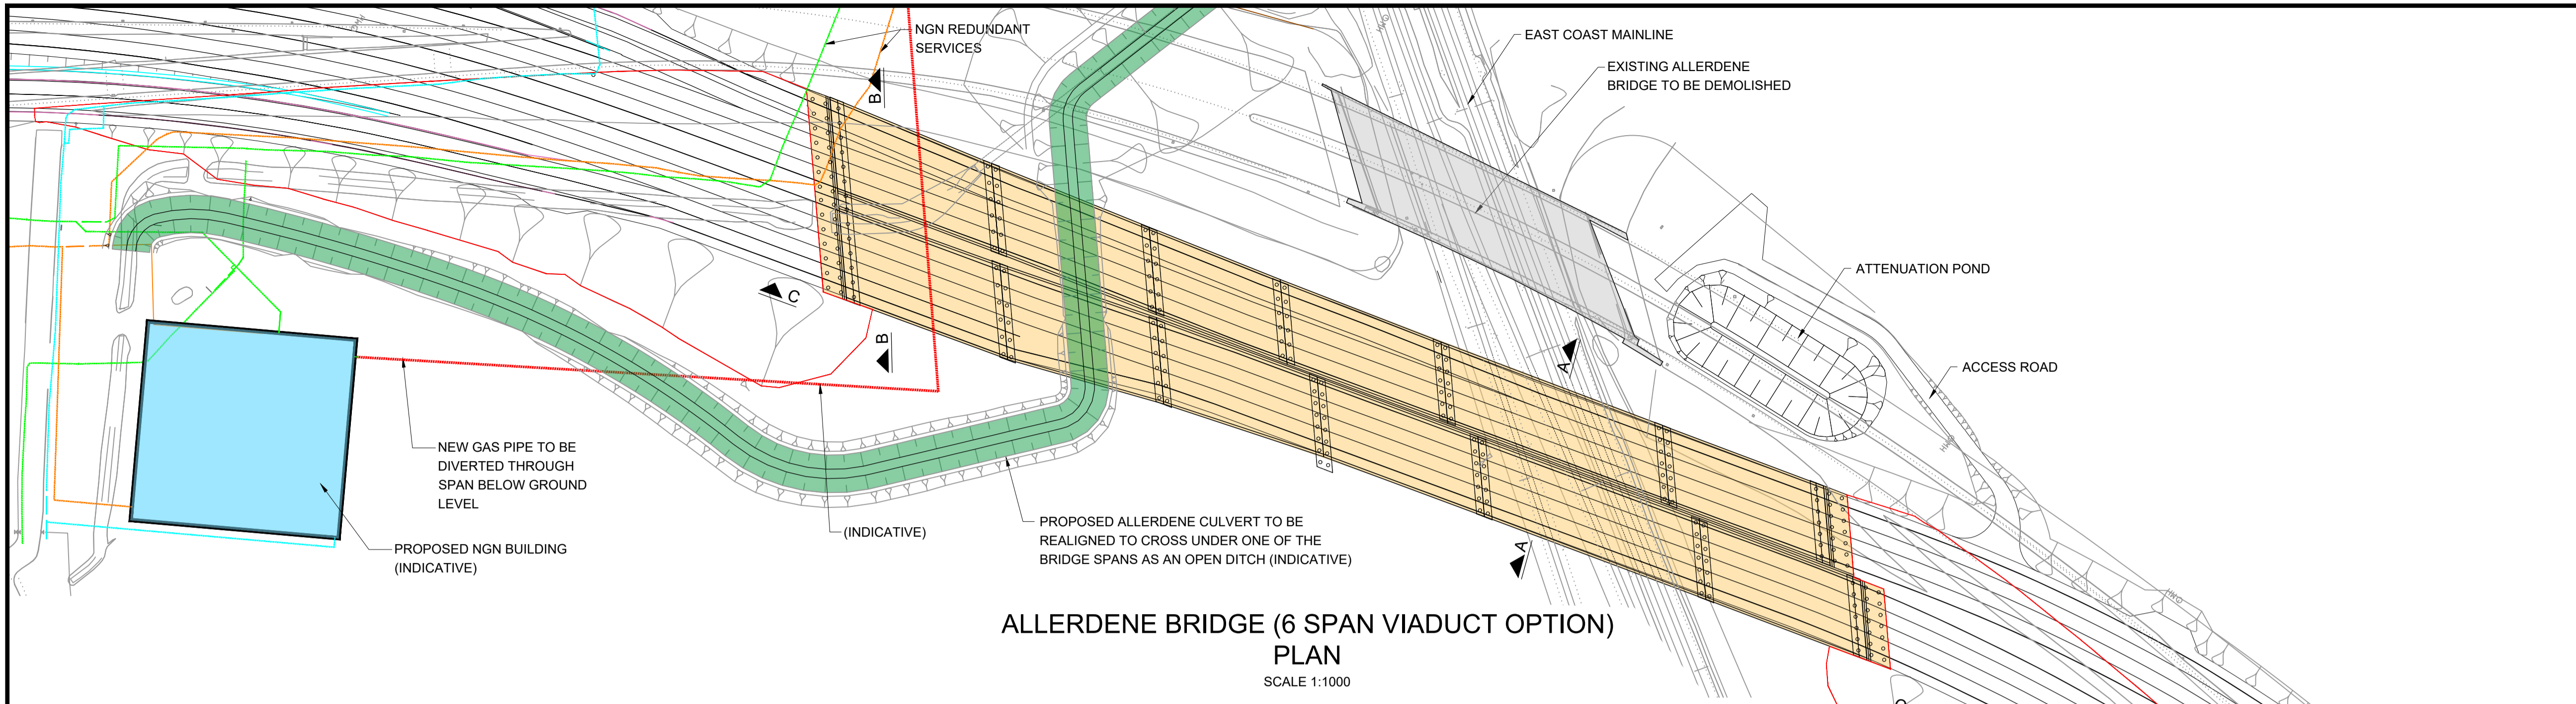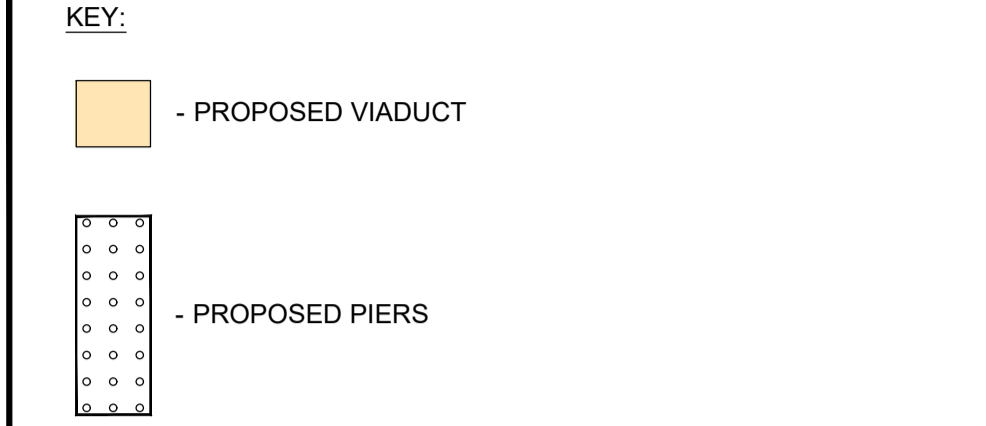


**ALLERDENE BRIDGE (6 SPAN VIADUCT OPTION)
PLAN
SCALE 1:1000**

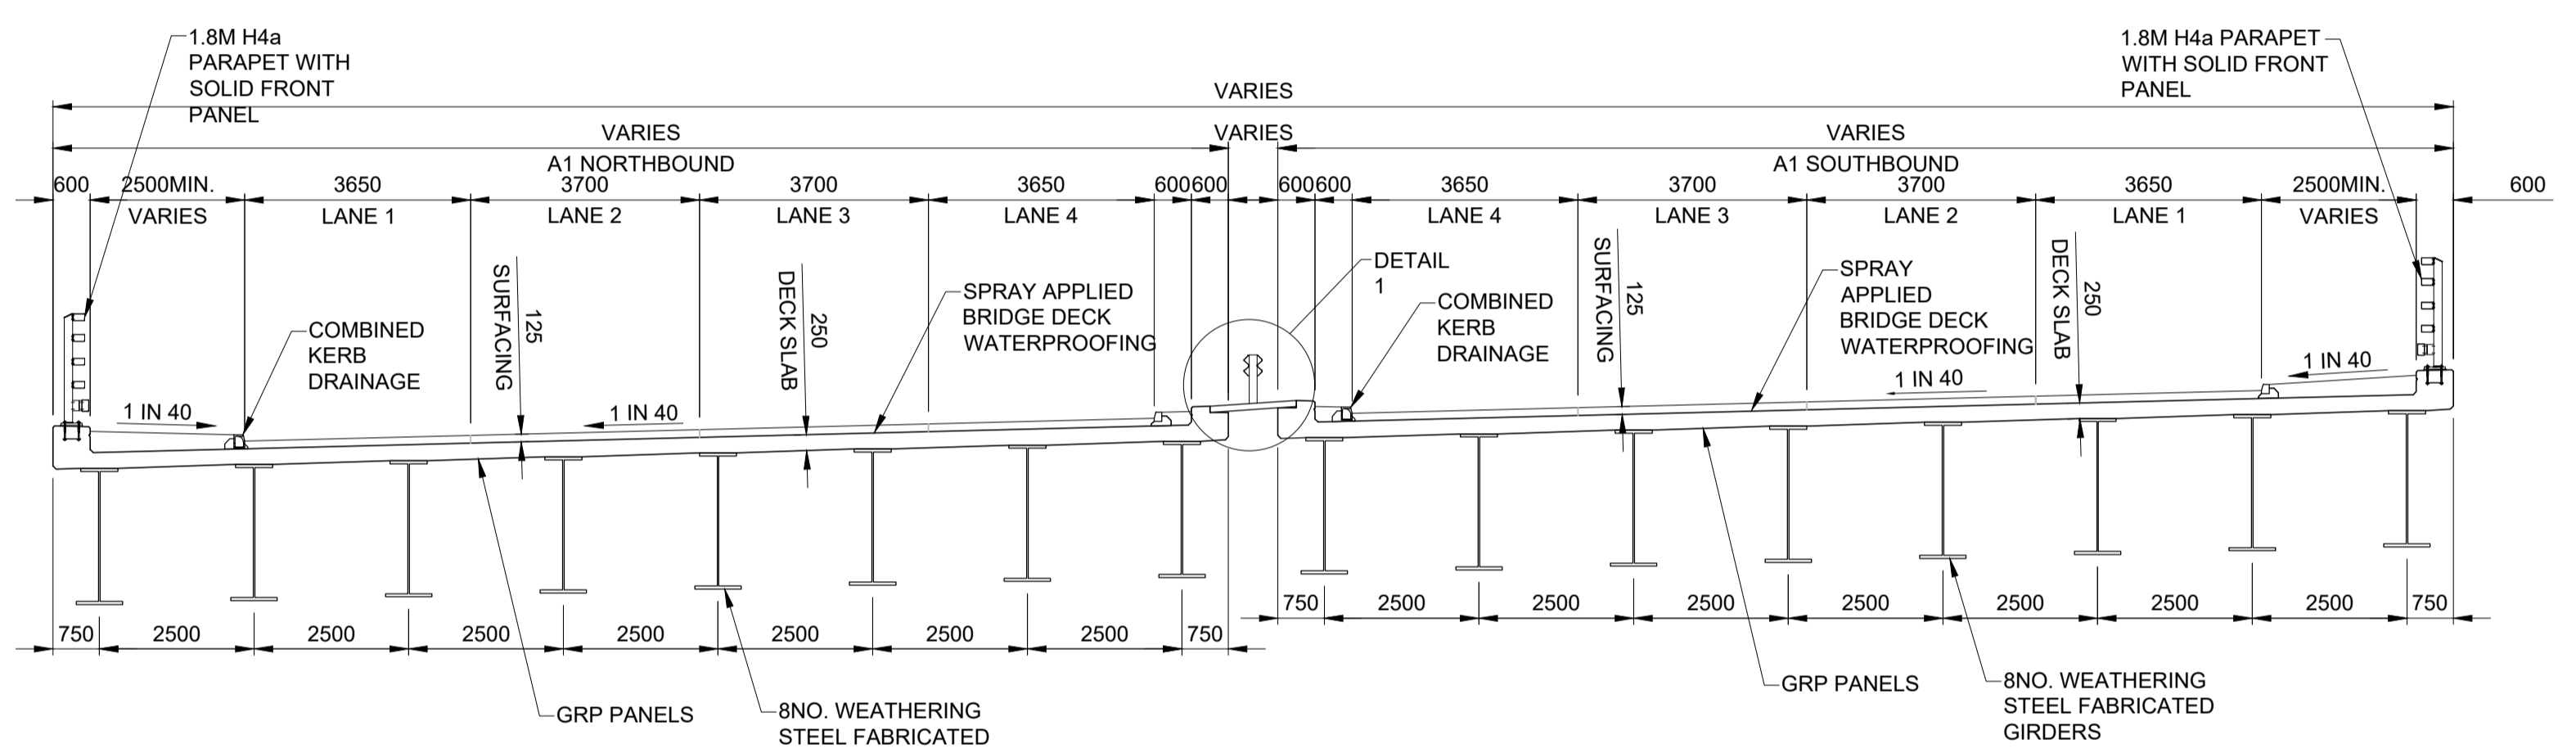



**ALLERDENE BRIDGE (6 SPAN VIADUCT OPTION)
SECTION A-A
SCALE 1:100**

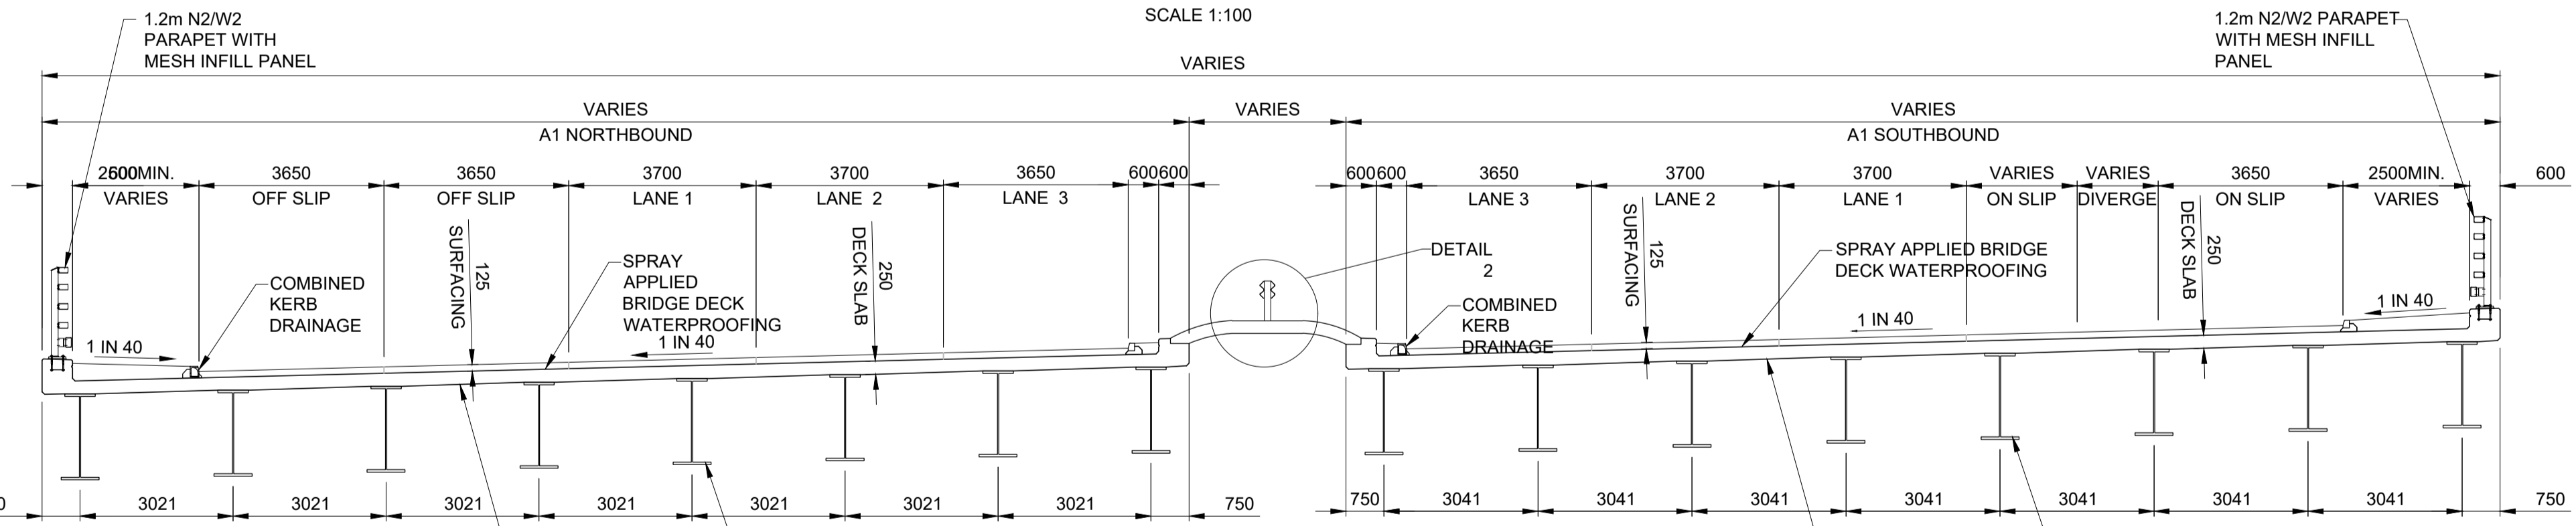

**ALLERDENE BRIDGE (6 SPAN VIADUCT OPTION)
SECTION B-B
SCALE 1:100**

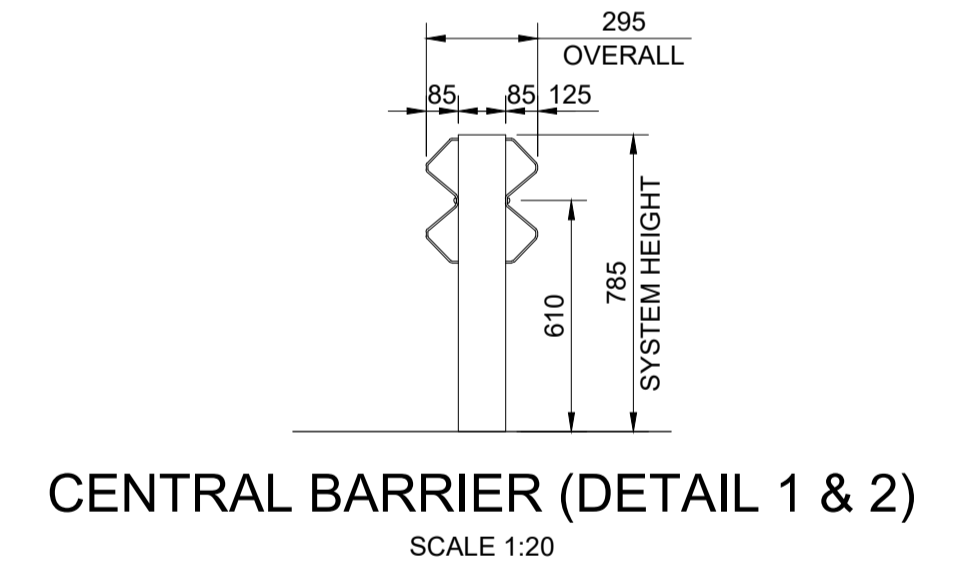

**CENTRAL BARRIER (DETAIL 1 & 2)
SCALE 1:20**

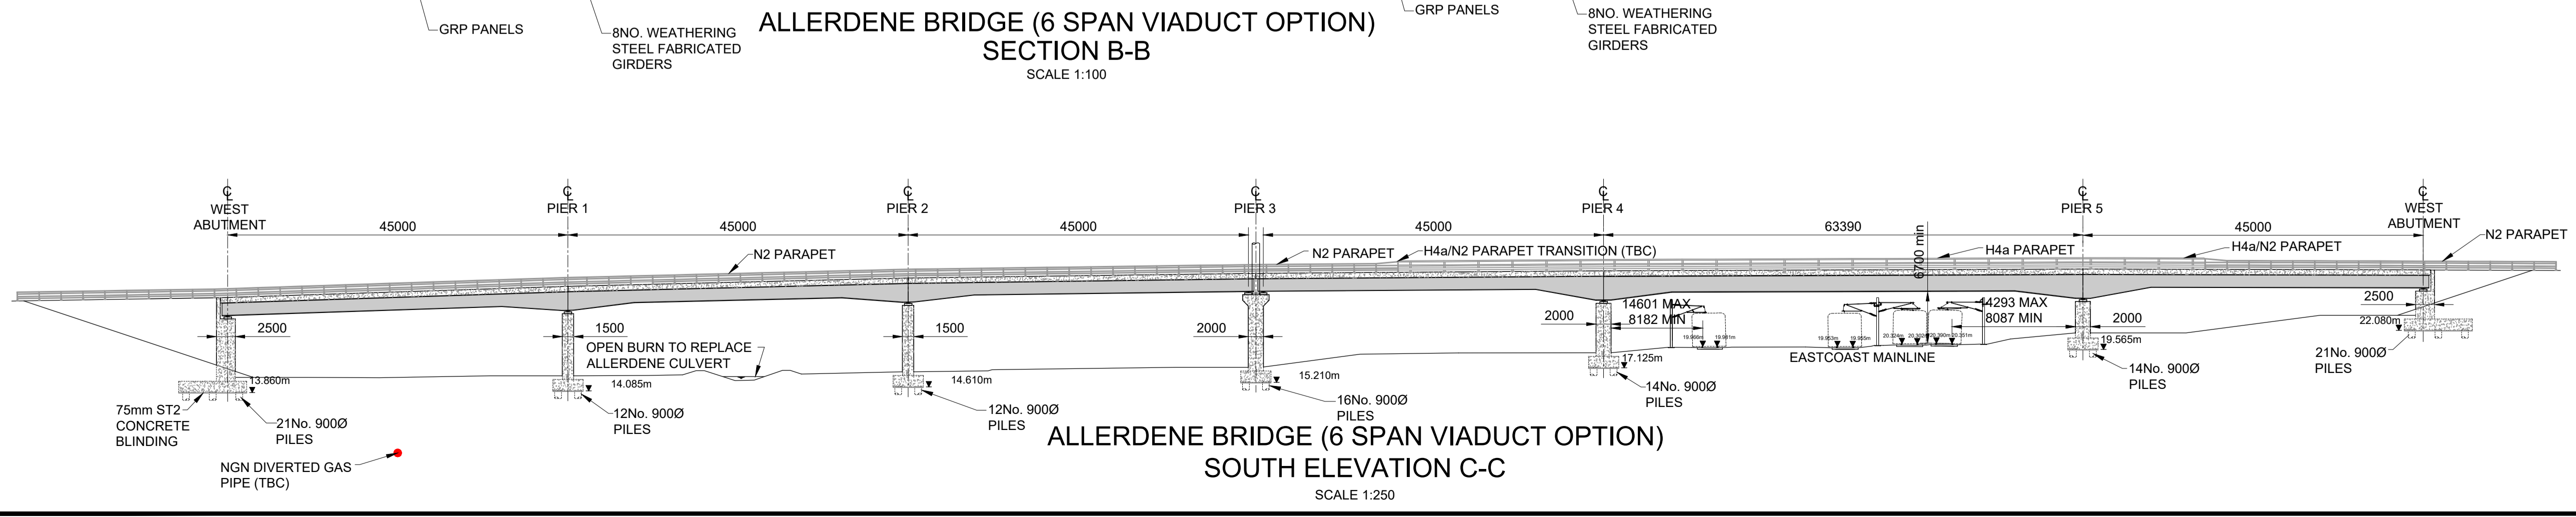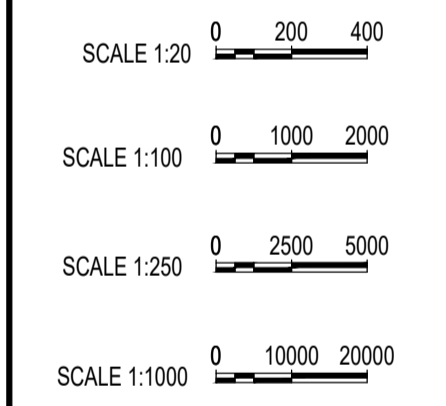

**ALLERDENE BRIDGE (6 SPAN VIADUCT OPTION)
SOUTH ELEVATION C-C
SCALE 1:250**

Rev.	Date	Description	By	Eng' Chk	Disc' Chk	App'd	Status
1	25/02/20	For Examination Deadline 2		RA	IA	IA	NR
0	27/09/19	For Application		RA	IA	IA	NR

For Examination Deadline 2 A3

PINS Reference Number: **TR010031/APP/2.7(E)**

Client:

Project Title: **A1 BIRTLEY TO COAL HOUSE**



Drawing Title: **STRUCTURES ENGINEERING DRAWINGS & SECTIONS REGULATION 5(2)(o) ALLERDENE BRIDGE (6 SPAN VIADUCT OPTION) (SHEET 4 OF 14)**

Scale	Drawn	Eng. Check	Approved	Authorised
N/A	R.Ayre	I.Akram	I.Akram	N.Rawcliffe


Original Size	Date	Date	Date	Date
A1	25/02/20	25/02/20	25/02/20	25/02/20

Confidential


- NOTES:
- ALL DIMENSION ARE IN MILLIMETRES UNLESS NOTED OTHERWISE.
 - ALL LEVELS AND CHAINAGES ARE IN METRES UNLESS NOTED OTHERWISE.
 - DO NOT SCALE. IN CASE OF DOUBTS, OMISSIONS OR ERRORS SEEK CLARIFICATION FROM THE DESIGNER.

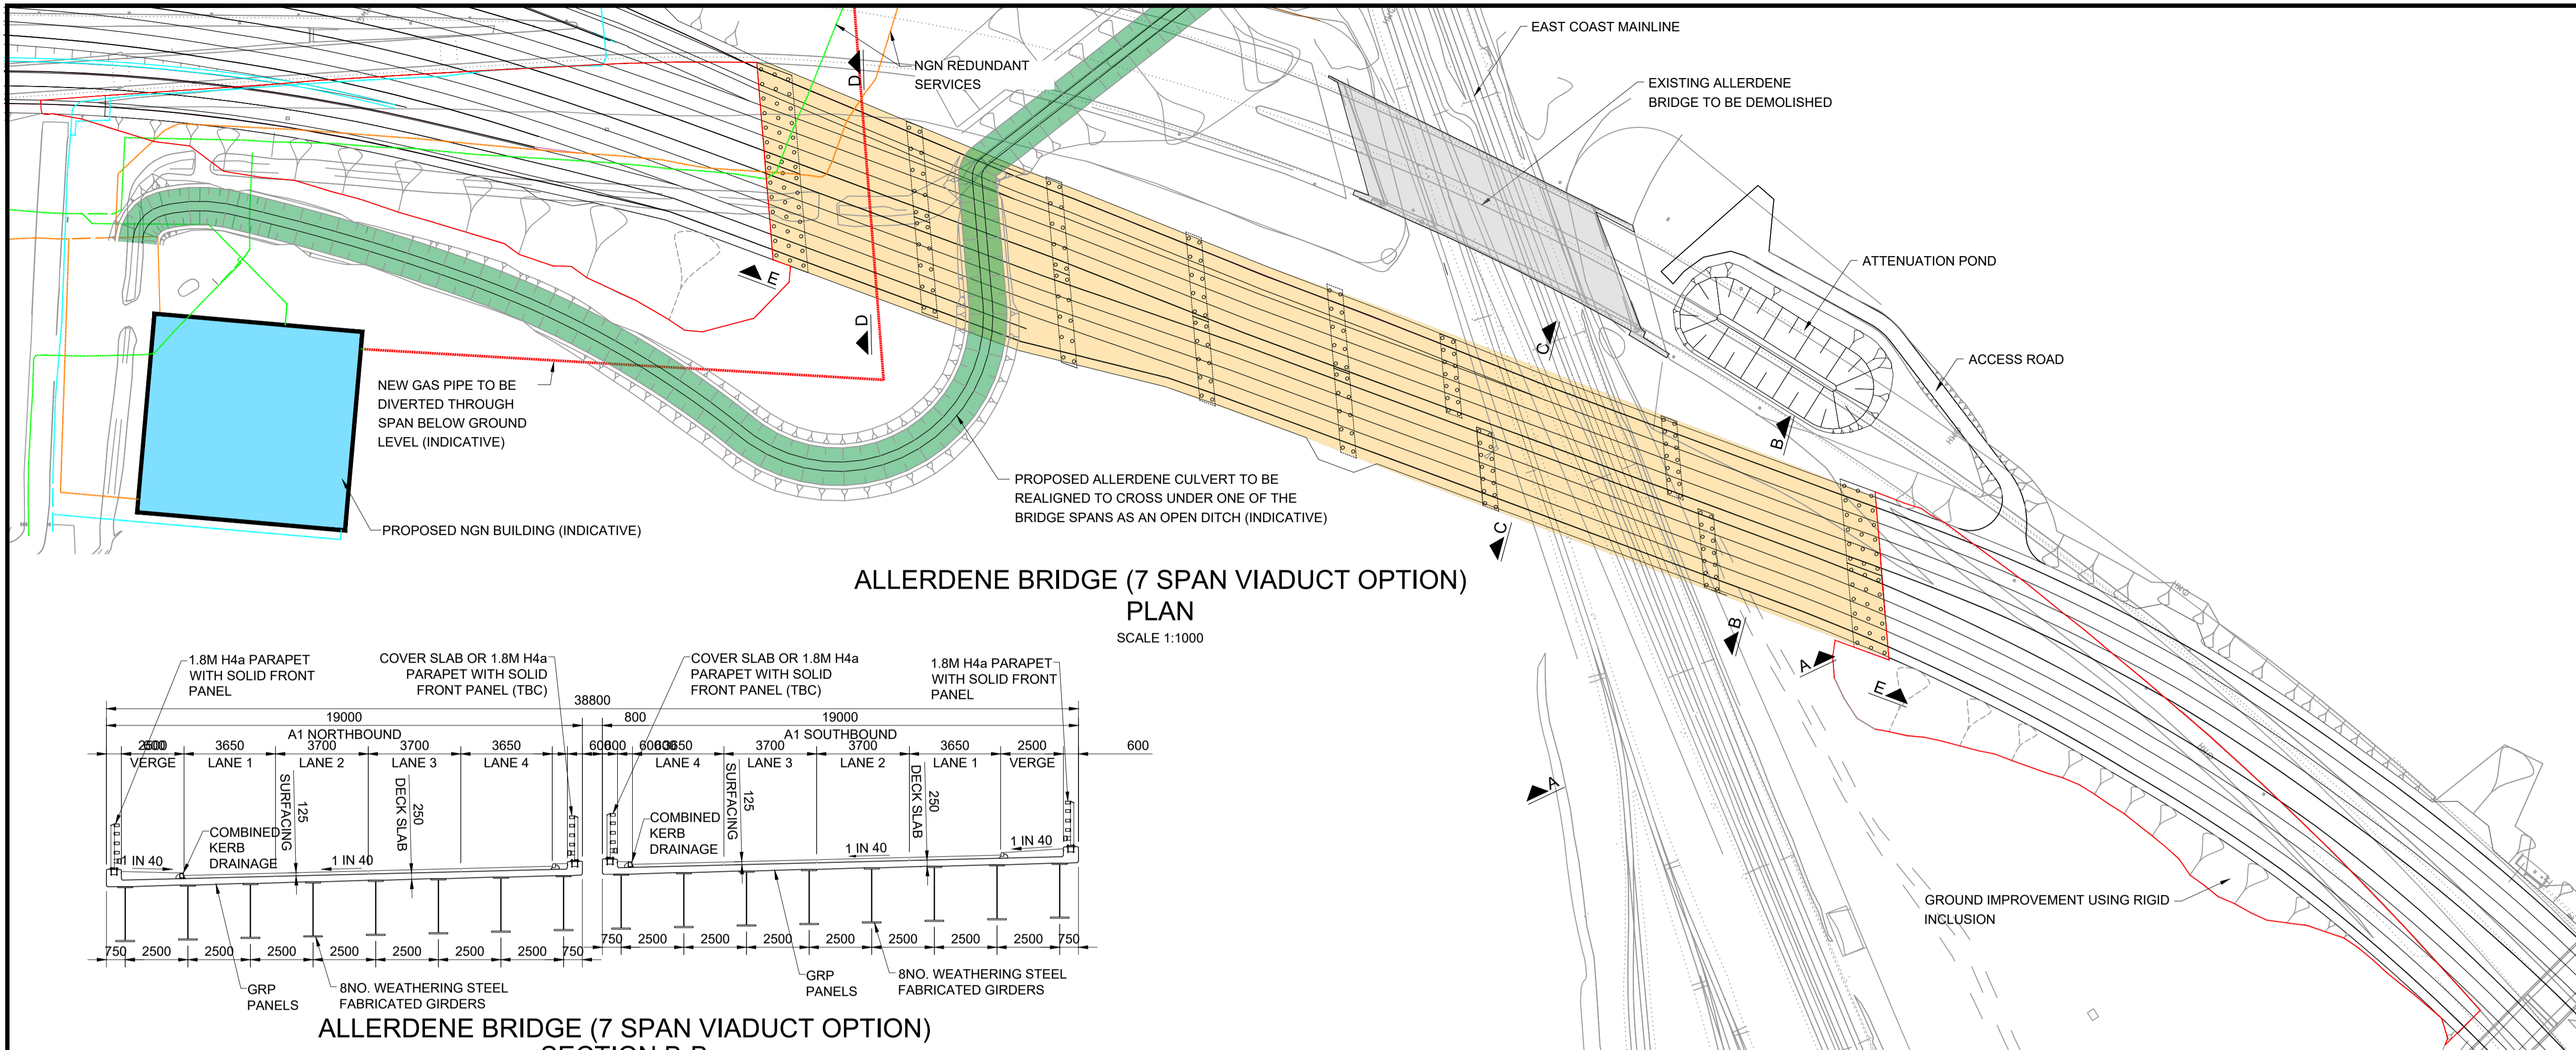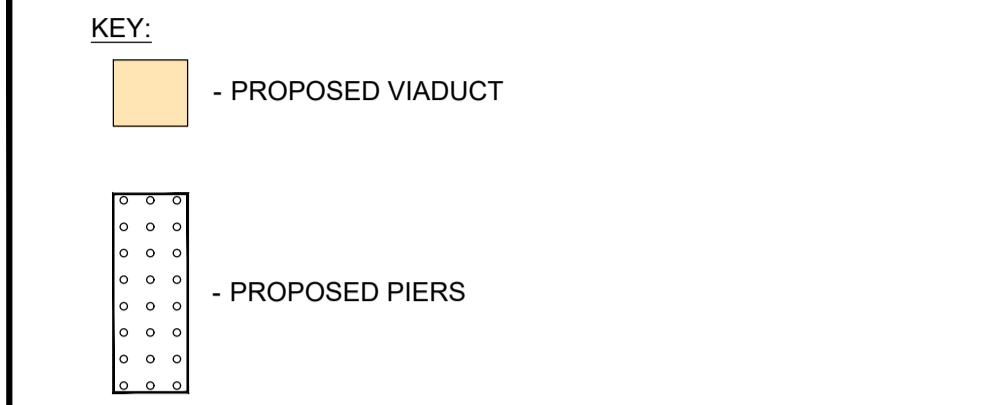


ALLERDENE BRIDGE (7 SPAN VIADUCT OPTION)
PLAN
SCALE 1:1000

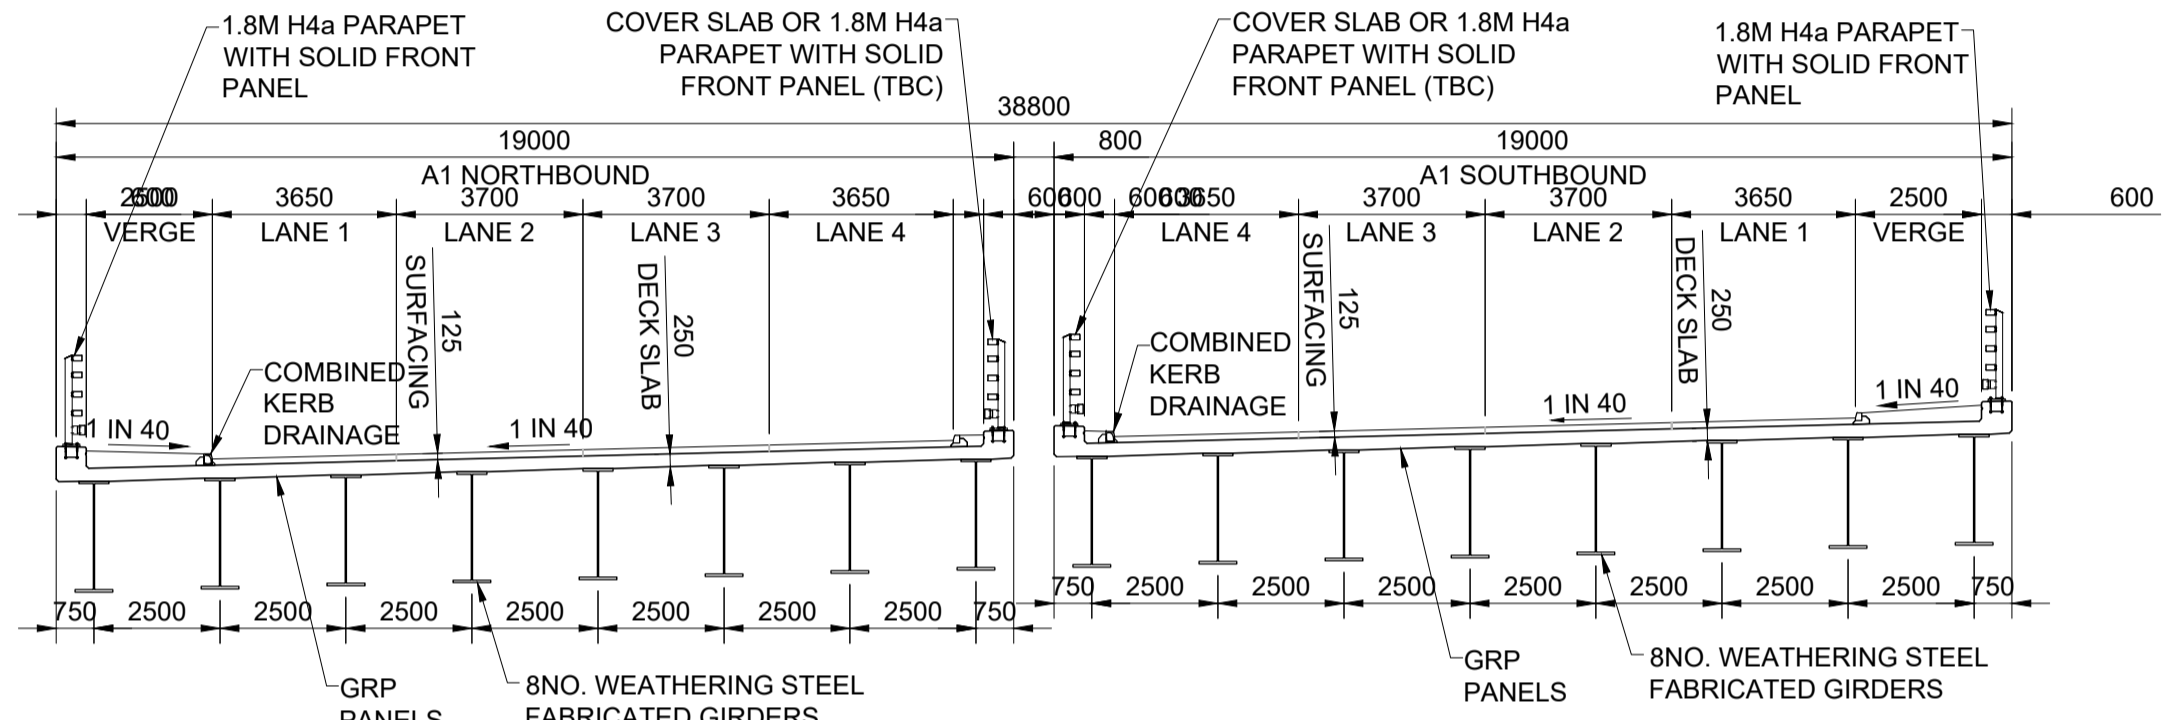


ALLERDENE BRIDGE (7 SPAN VIADUCT OPTION)
SECTION B-B
SCALE 1:150

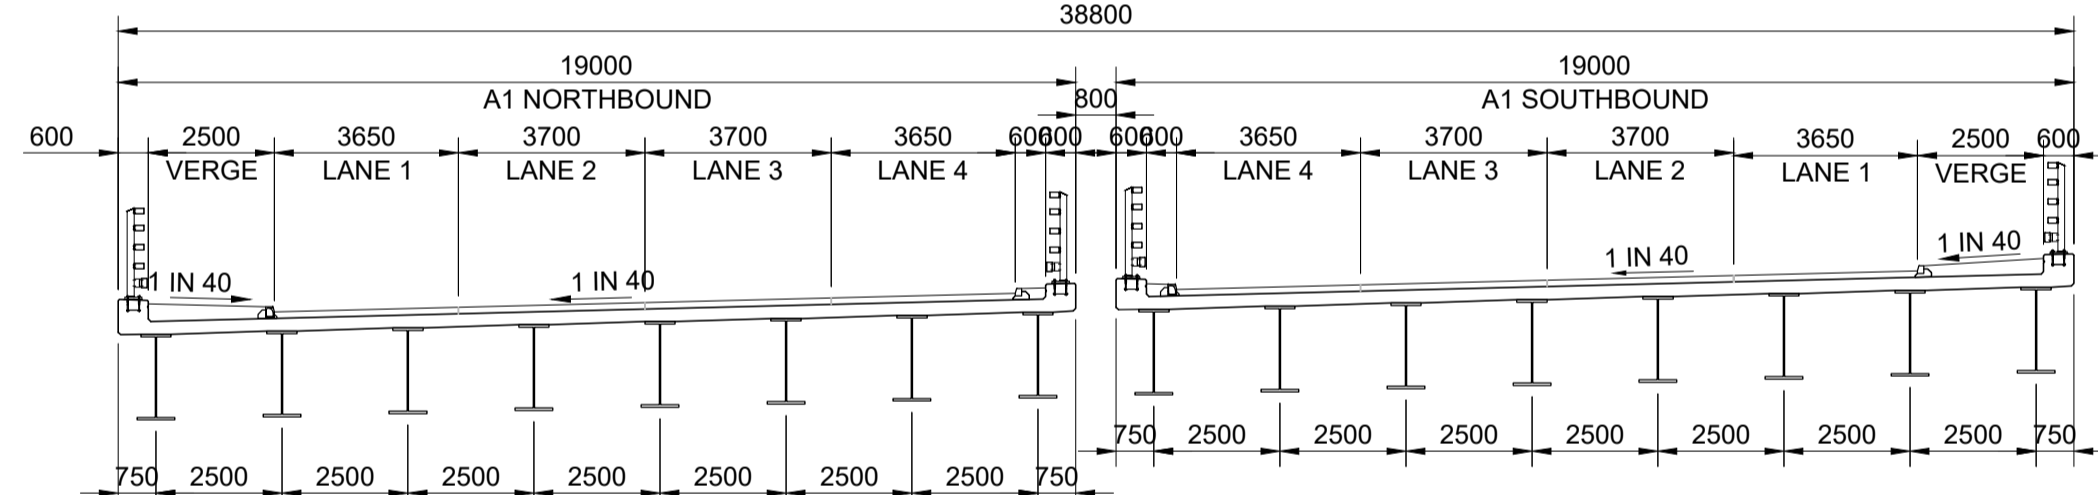



ALLERDENE BRIDGE (7 SPAN VIADUCT OPTION)
SECTION C-C
SCALE 1:150

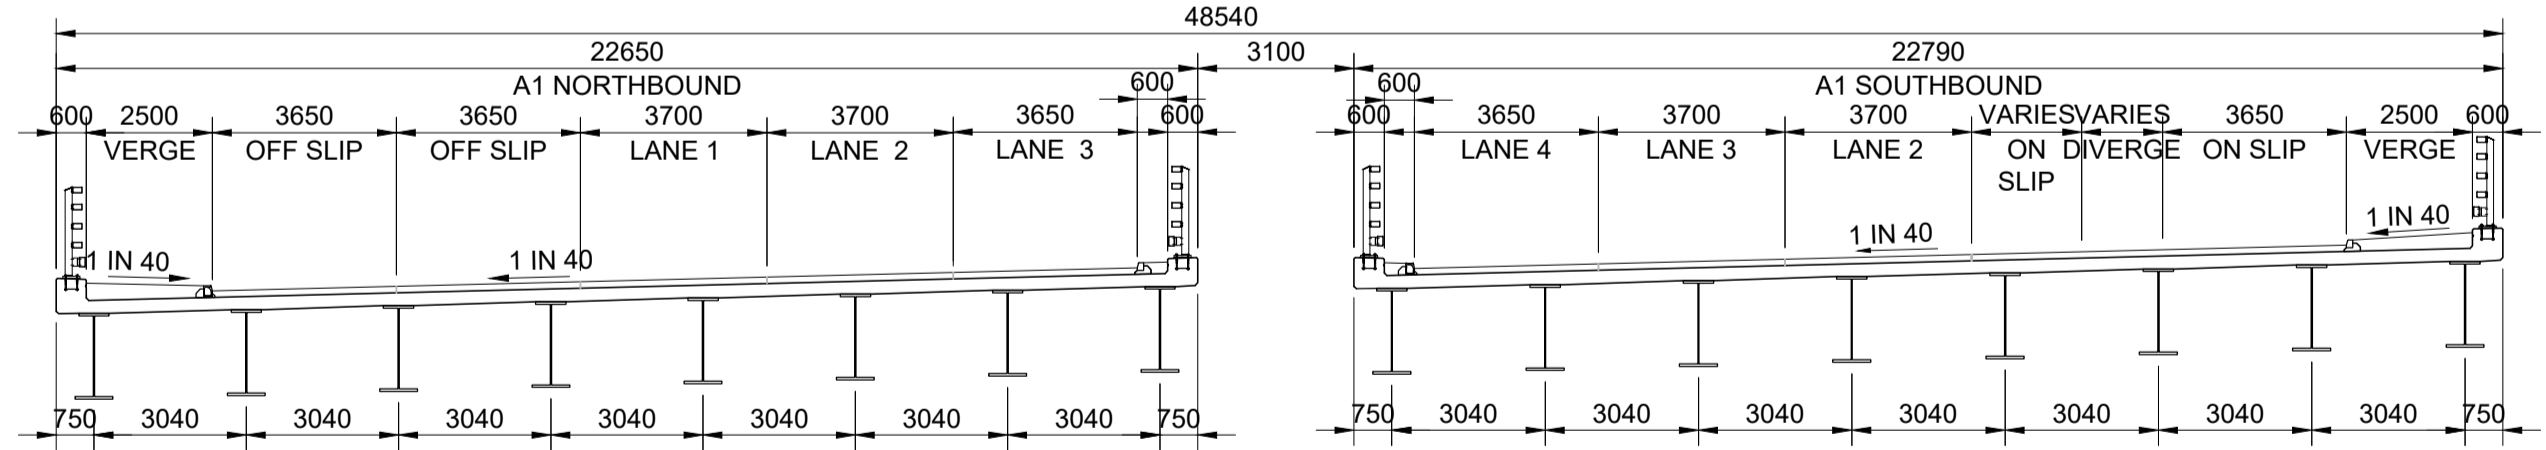

ALLERDENE BRIDGE (7 SPAN VIADUCT OPTION)
SECTION D-D
SCALE 1:150

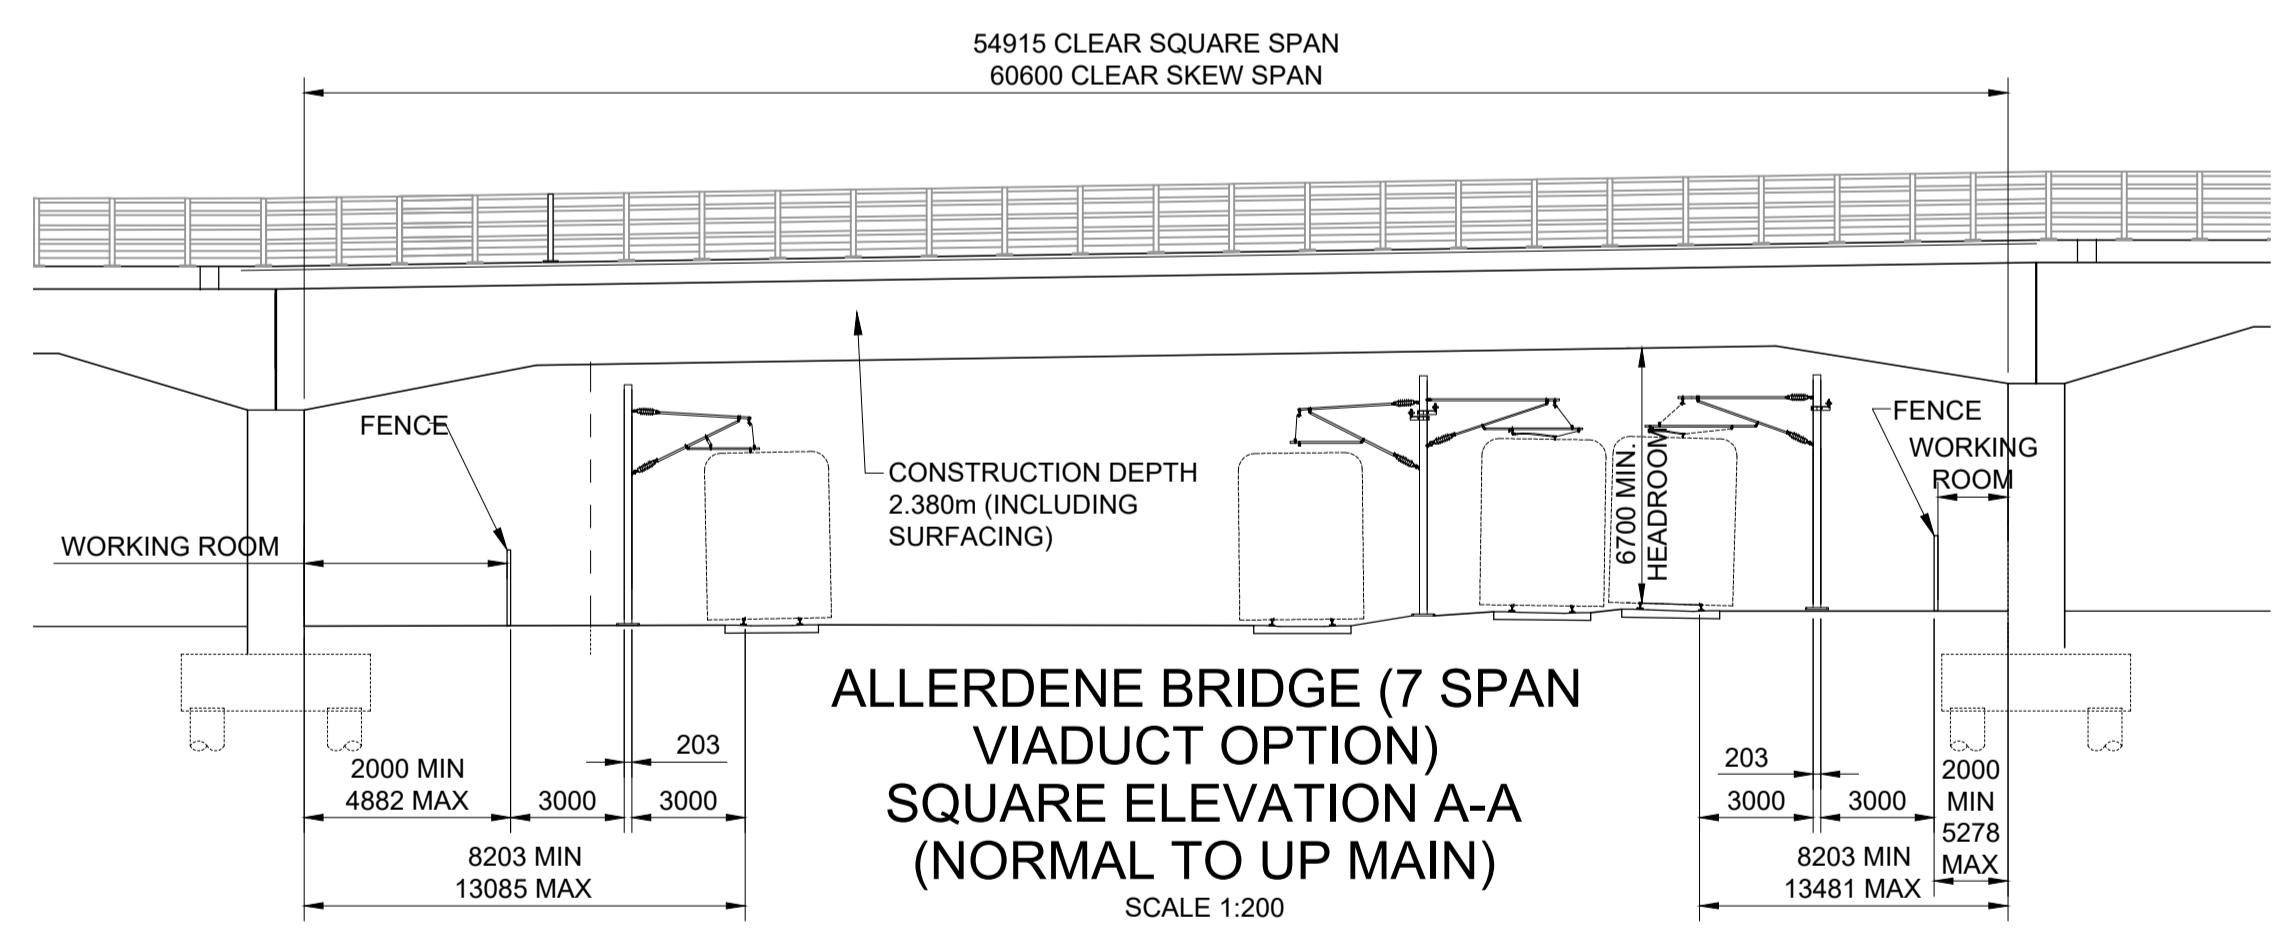

ALLERDENE BRIDGE (7 SPAN VIADUCT OPTION)
SQUARE ELEVATION A-A
(NORMAL TO UP MAIN)
SCALE 1:200

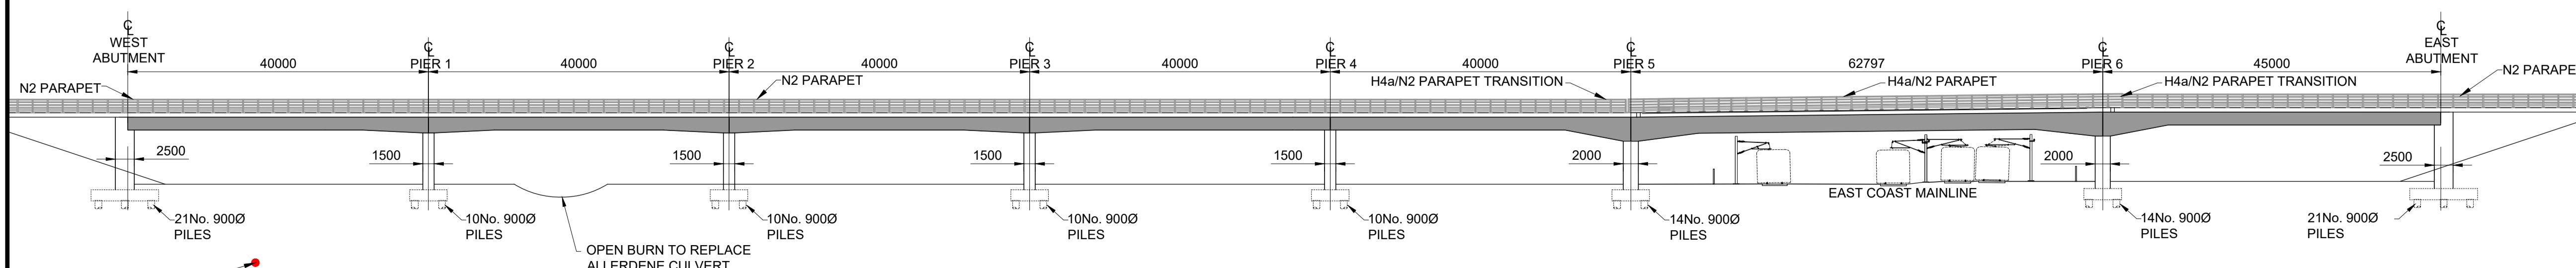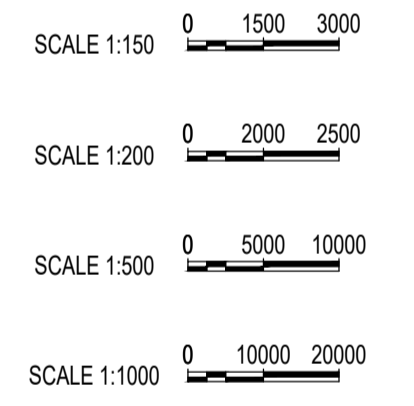

ALLERDENE BRIDGE (7 SPAN VIADUCT OPTION)
SOUTH ELEVATION E-E
SCALE 1:500

Rev.	Date	Description	By	Eng' Chk	Disc' Chk	App'd
1	25/02/20	For Examination Deadline 2		RA	IA	IA NR
0	27/09/19	For Application		RA	IA	IA NR

For Examination Deadline 2 A3

TR010031/APP/2.7(F)



A1 BIRTLEY TO COAL HOUSE

STRUCTURES ENGINEERING DRAWINGS & SECTIONS REGULATION 5(2)(o)
ALLERDENE BRIDGE (7 SPAN VIADUCT OPTION)
(SHEET 5 OF 14)

Scale	Drawn	Eng. Check	Approved	Authorised
N/A	R.Ayre	I.Akram	I.Akram	N.Rawcliffe


Original Size	Date	Date	Date	Date
A1	25/02/20	25/02/20	25/02/20	25/02/20

Drawing Number	Originator	Volume	Revision
HE551462	WSP	LSI	1


Confidential

NOTES:


1. ALL DIMENSION ARE IN MILLIMETRES UNLESS NOTED OTHERWISE.
2. ALL LEVELS AND CHAINAGES ARE IN METRES UNLESS NOTED OTHERWISE.
3. DO NOT SCALE. IN CASE OF DOUBTS, OMISSIONS OR ERRORS SEEK CLARIFICATION FROM THE DESIGNER.

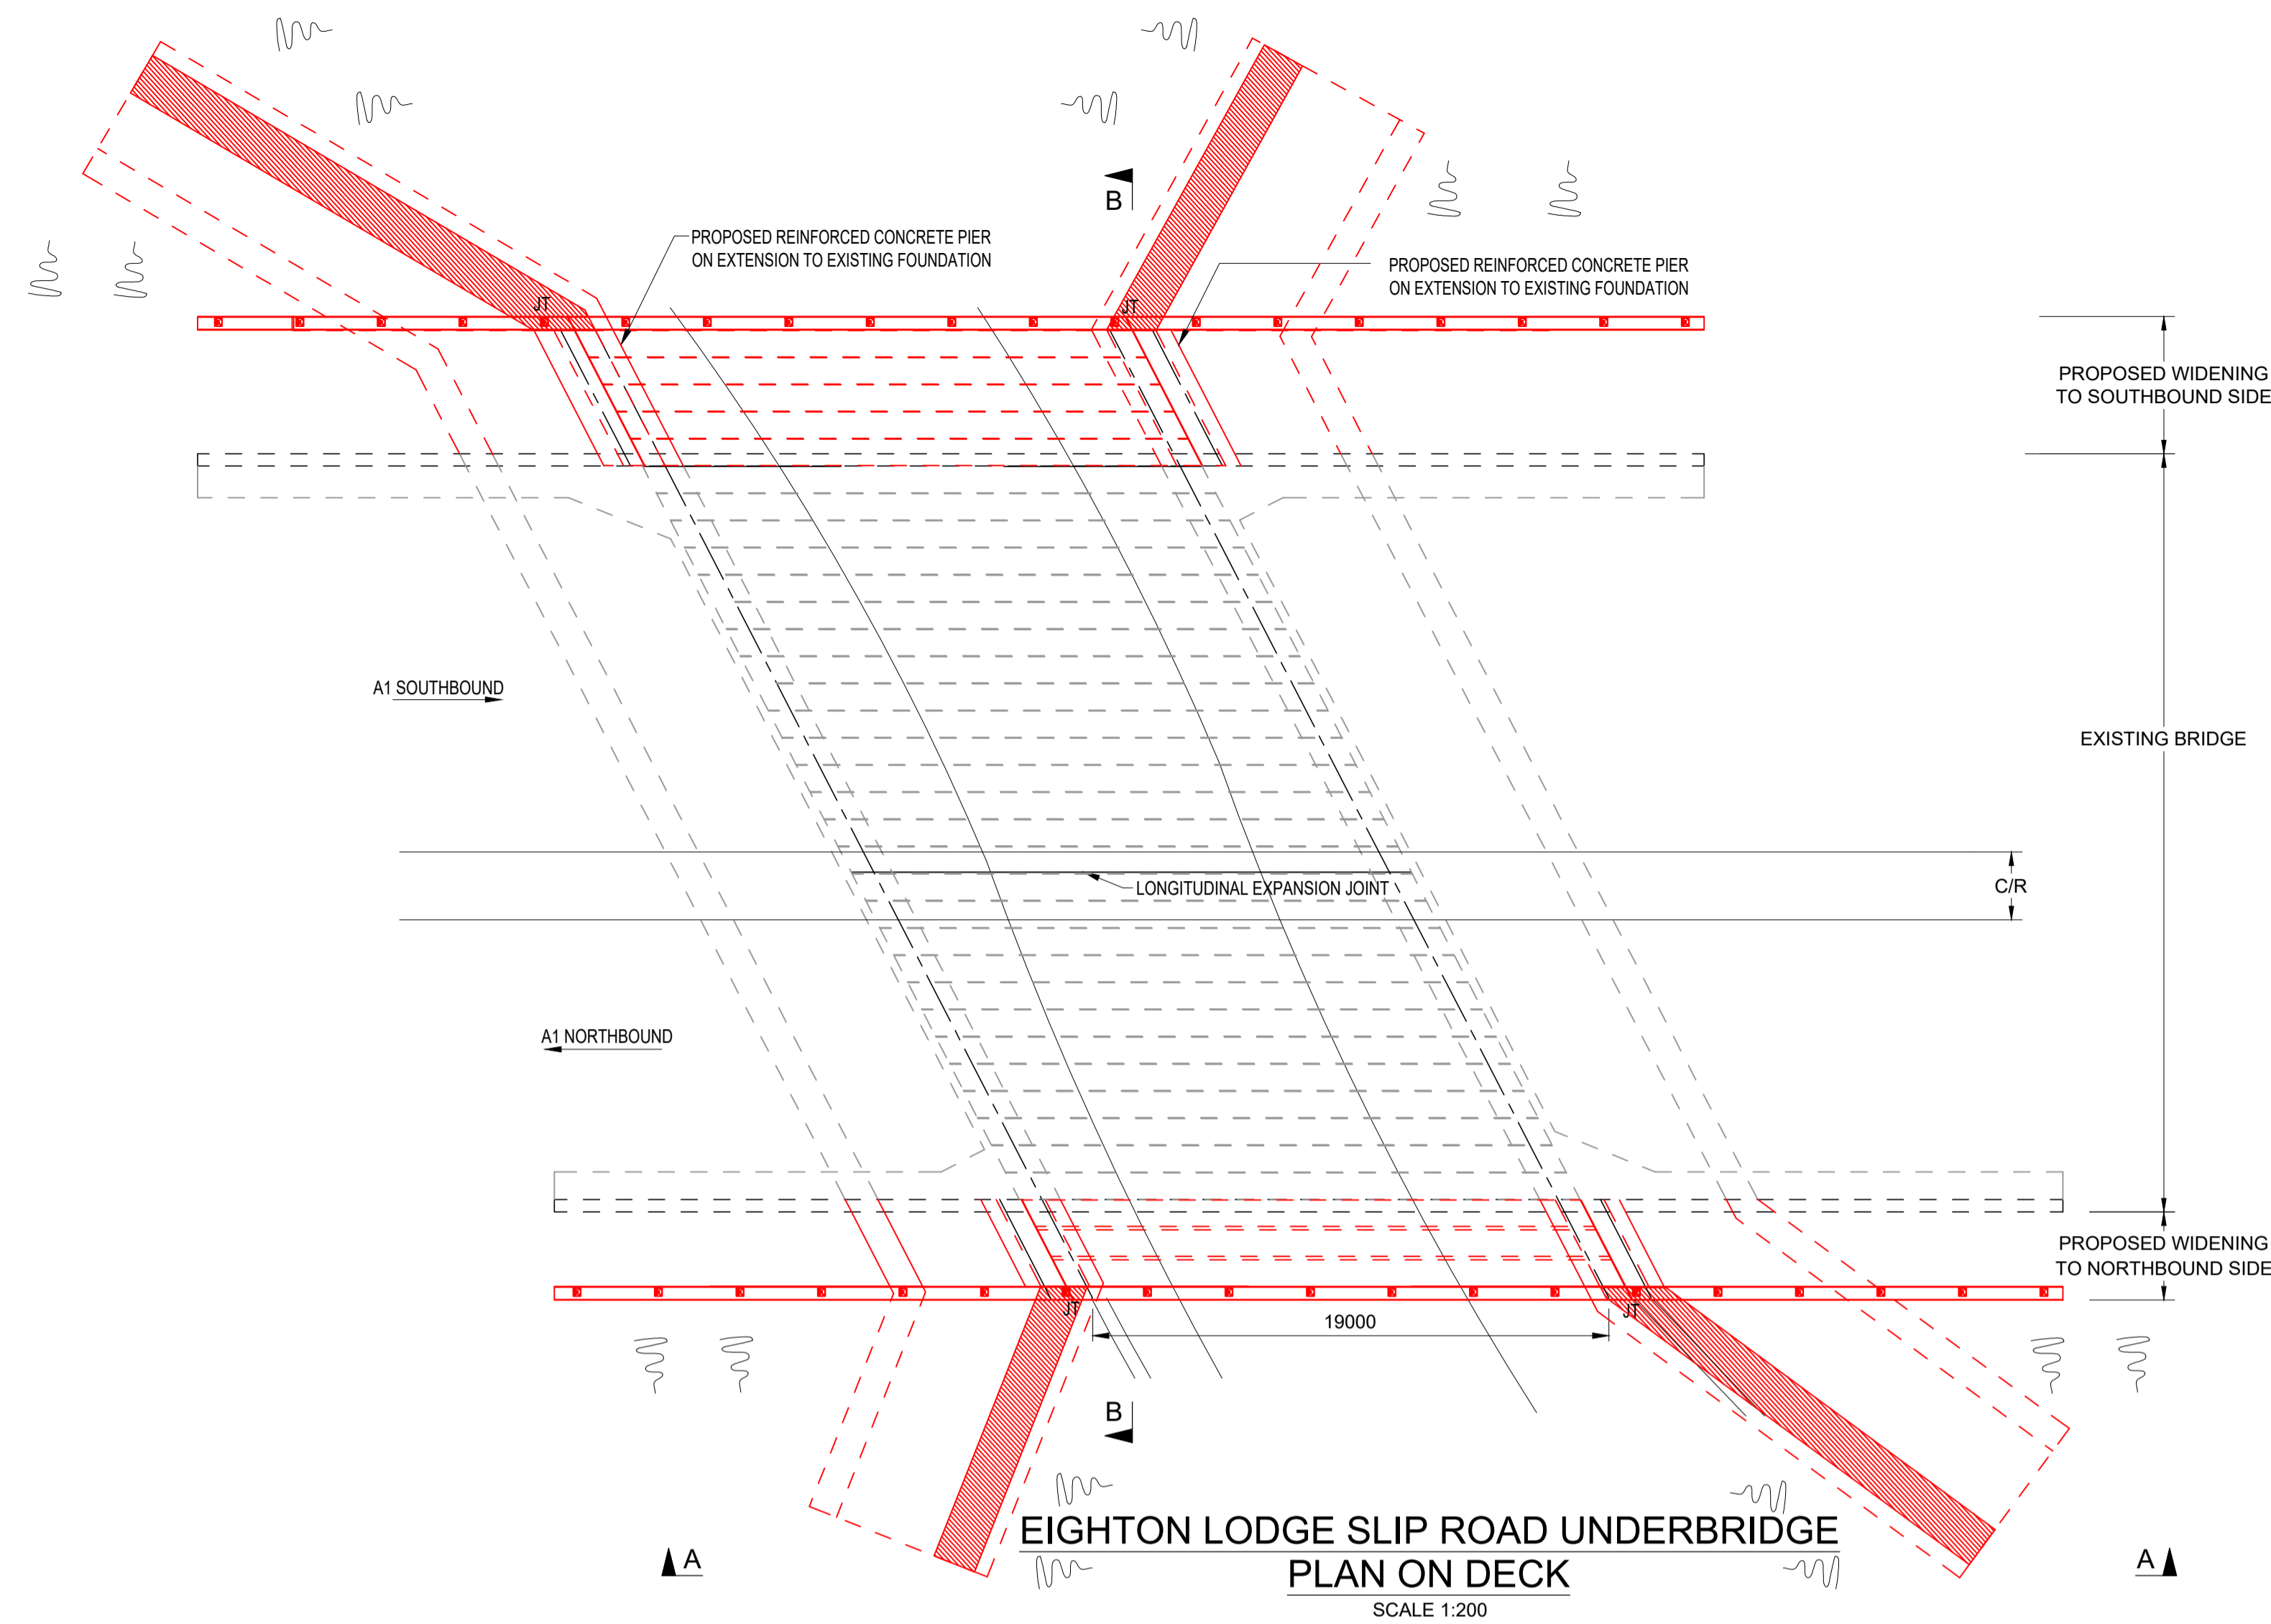


EIGHTON LODGE SLIP ROAD UNDERBRIDGE
PLAN ON DECK
 SCALE 1:200

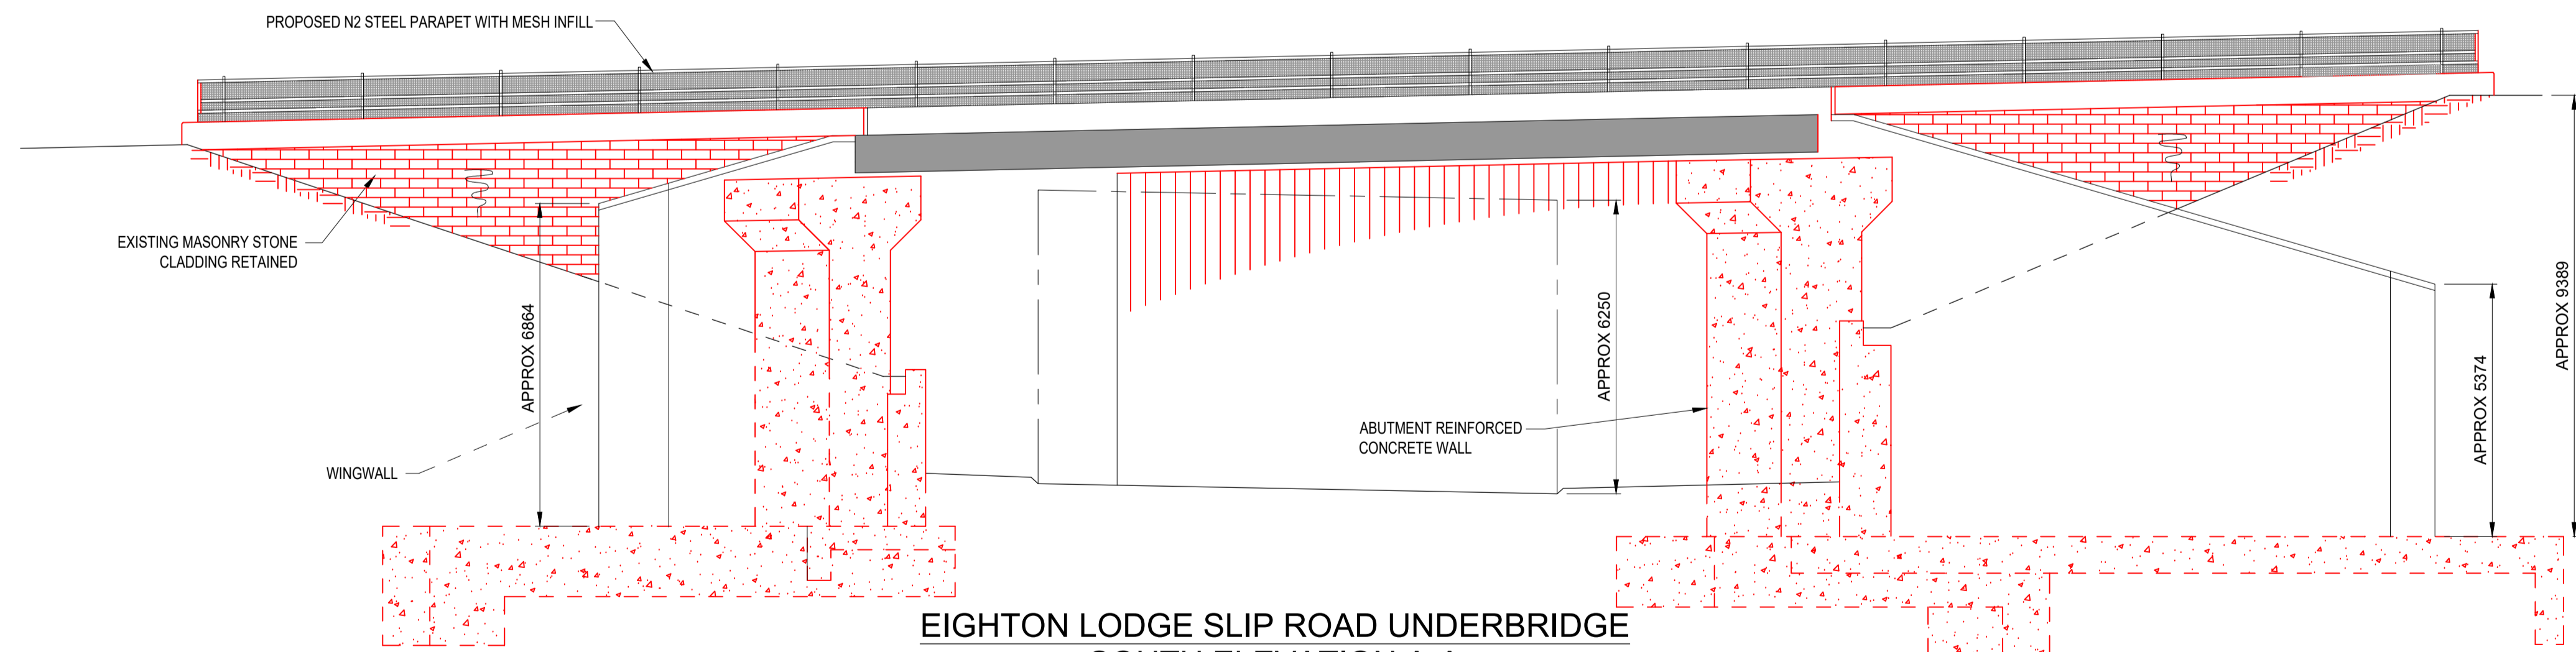

EIGHTON LODGE SLIP ROAD UNDERBRIDGE
SOUTH ELEVATION A-A
 SCALE 1:100

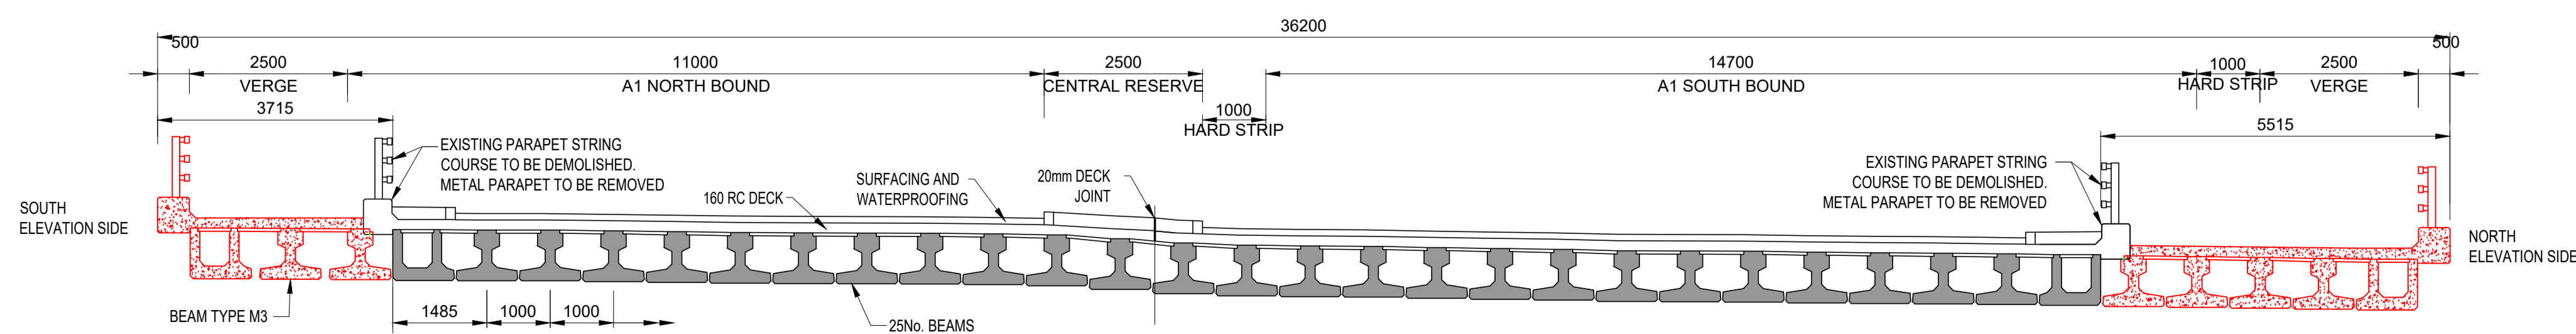

EIGHTON LODGE SLIP ROAD UNDERBRIDGE
SECTION B-B
 SCALE 1:75

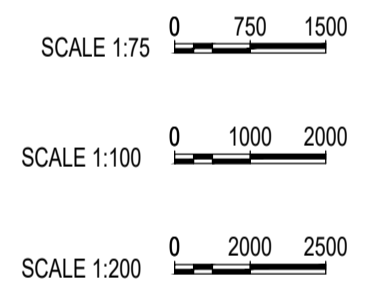

Rev.	Date	Description	By	Eng' Chk	Disc' Chk	App'd	Status
1	25/02/20	For Examination Deadline 2		RA	IA	IA	NR
0	27/09/19	For Application		RA	IA	IA	NR

For Examination Deadline 2

A3

TR010031/APP/2.7(G)



A1 BIRTLEY TO COAL HOUSE

STRUCTURES ENGINEERING DRAWINGS
 & SECTIONS REGULATION 5(2)(o)
 EIGHTON LODGE SLIP ROAD UNDERBRIDGE
 (SHEET 6 OF 14)

Scale	Drawn	Eng. Check	Approved	Authorised
N/A	R.Ayre	I.Akram	I.Akram	N.Rawcliffe

Original Size	Date	Date	Date	Date
A1	25/02/20	25/02/20	25/02/20	25/02/20

Section	Type	ID	Direction	Type	Role	Number
ZZ				DR	ZL	45015

Drawing Number	Originator	Volume	Revision
HE551462	WSP	LSI	1

Section	Type	ID	Direction	Type	Role	Number
ZZ				DR	ZL	45015

Section	Type	ID	Direction	Type	Role	Number
ZZ				DR	ZL	45015

NOTES:


1. ALL DIMENSION ARE IN MILLIMETRES UNLESS NOTED OTHERWISE.
2. ALL LEVELS AND CHAINAGES ARE IN METRES UNLESS NOTED OTHERWISE.
3. DO NOT SCALE. IN CASE OF DOUBTS, OMISSIONS OR ERRORS SEEK CLARIFICATION FROM THE DESIGNER.

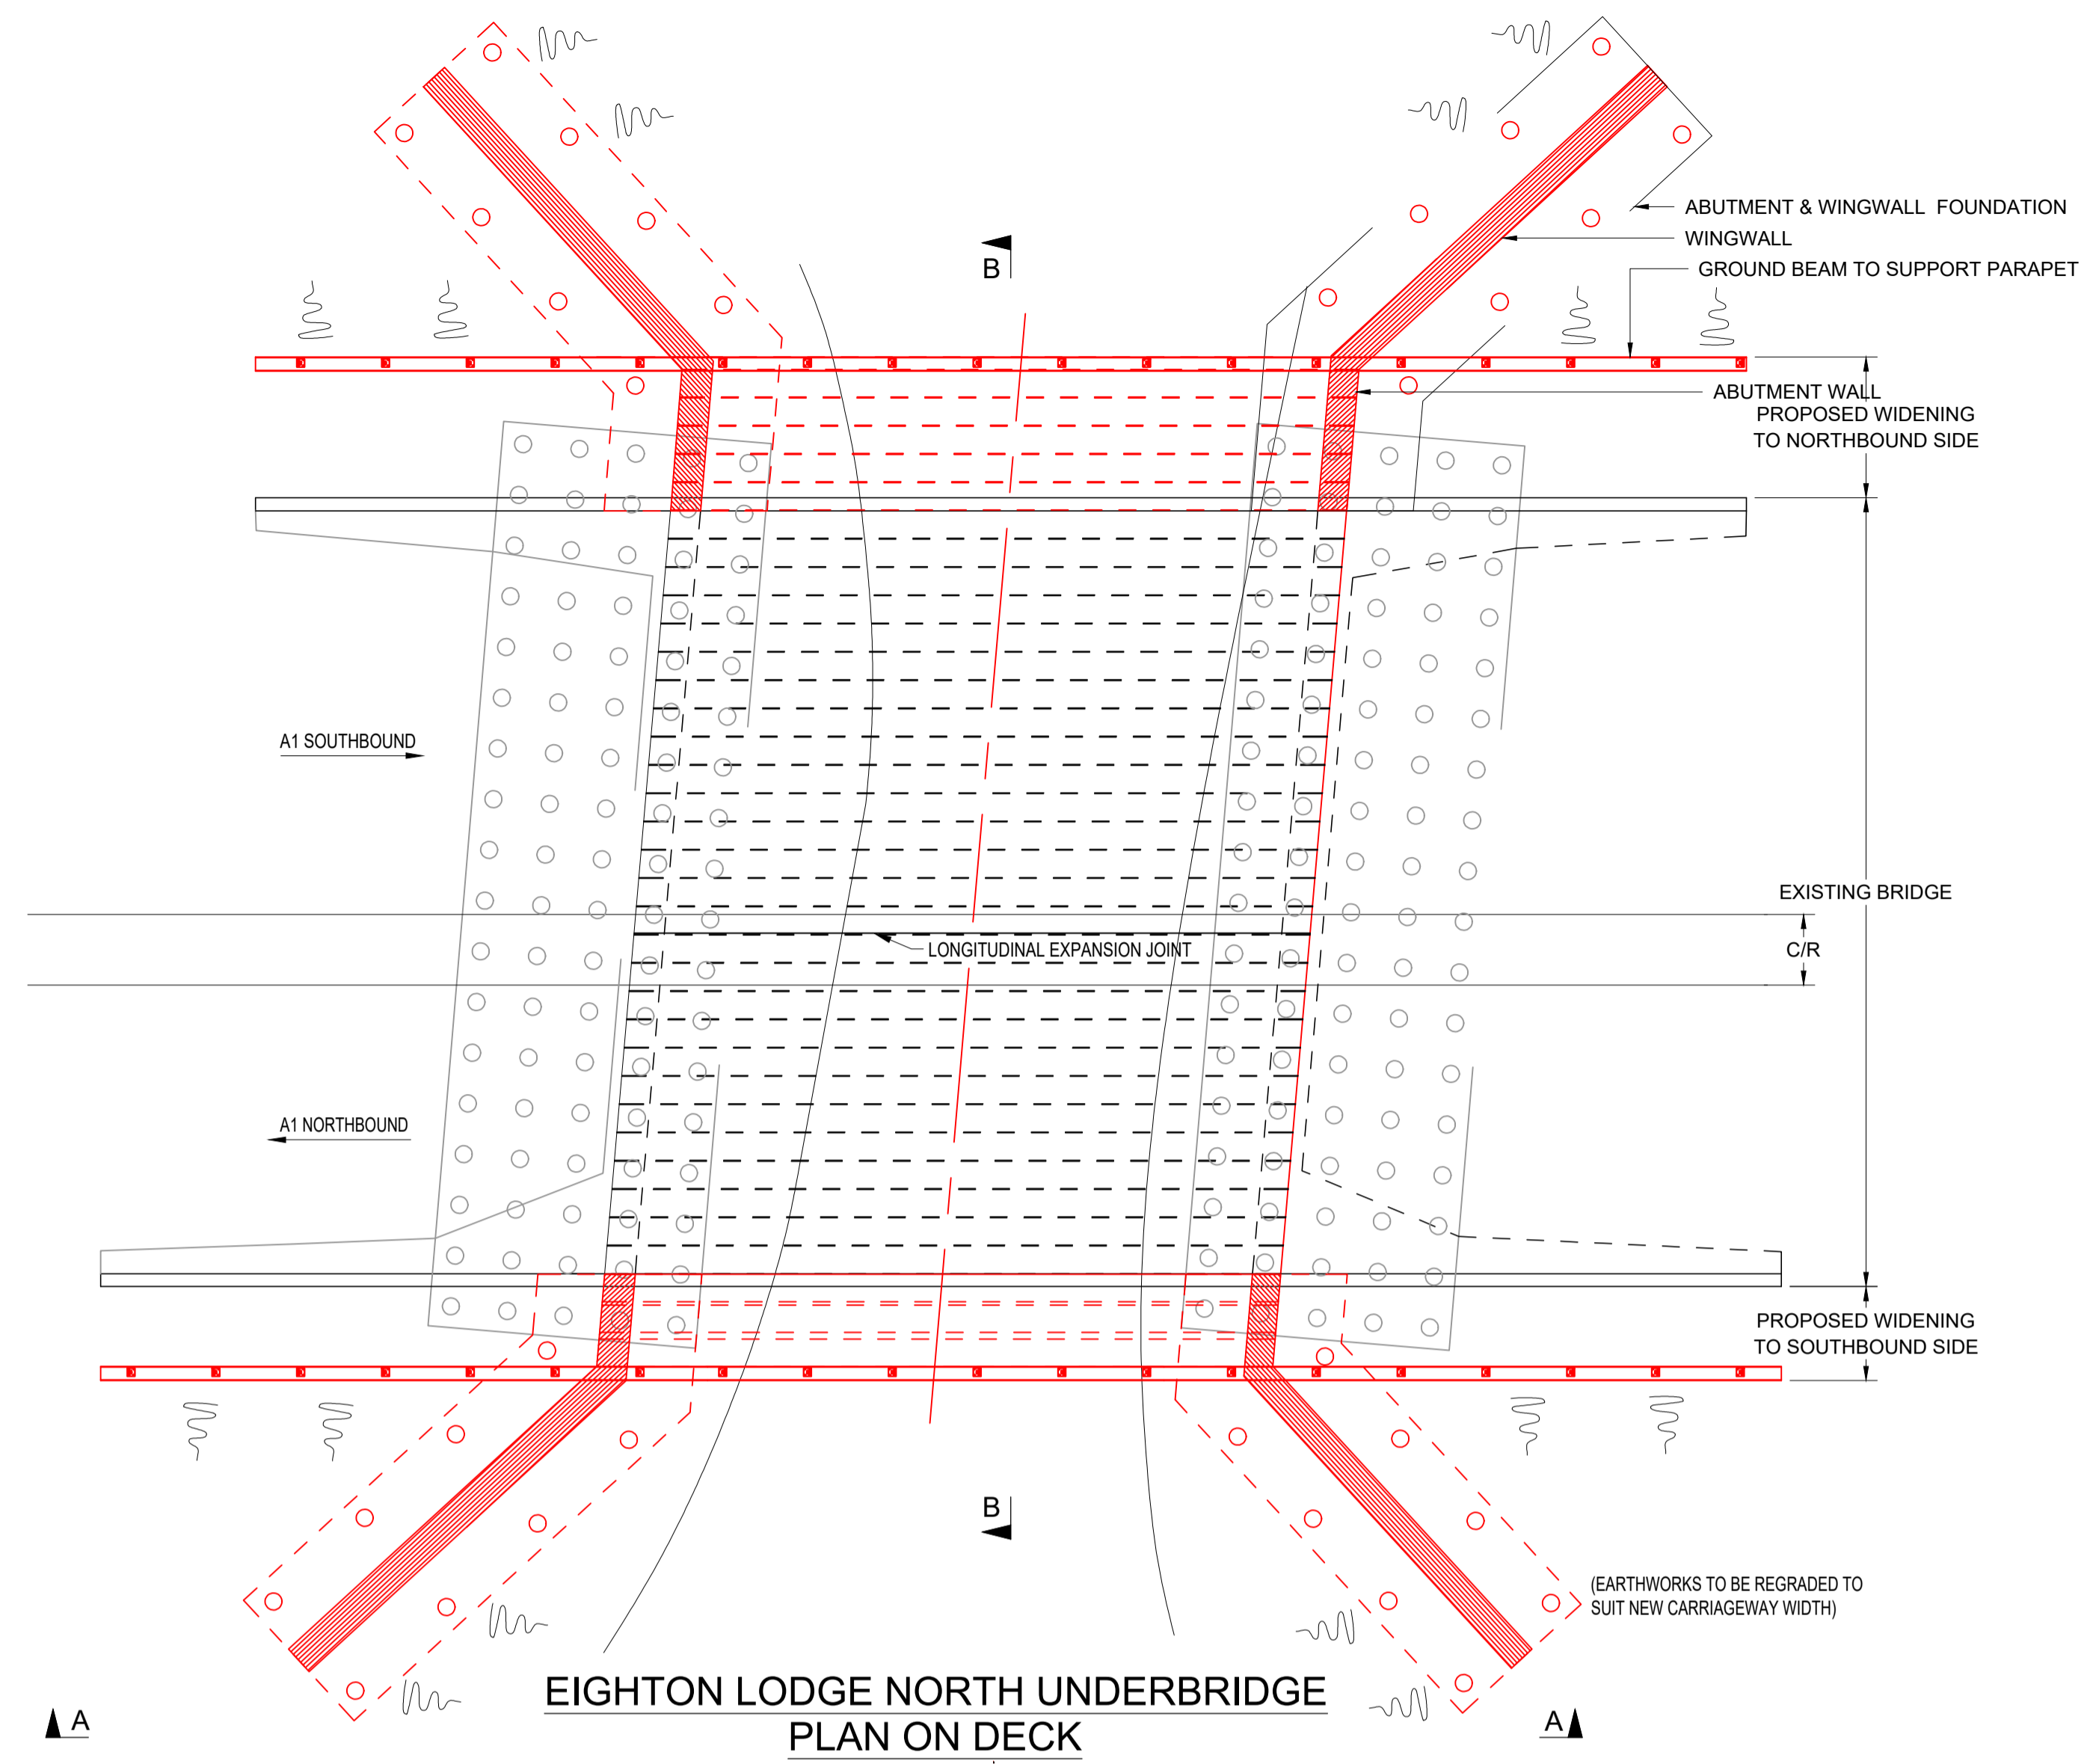


**EIGHTON LODGE NORTH UNDERBRIDGE
PLAN ON DECK**
SCALE 1:200

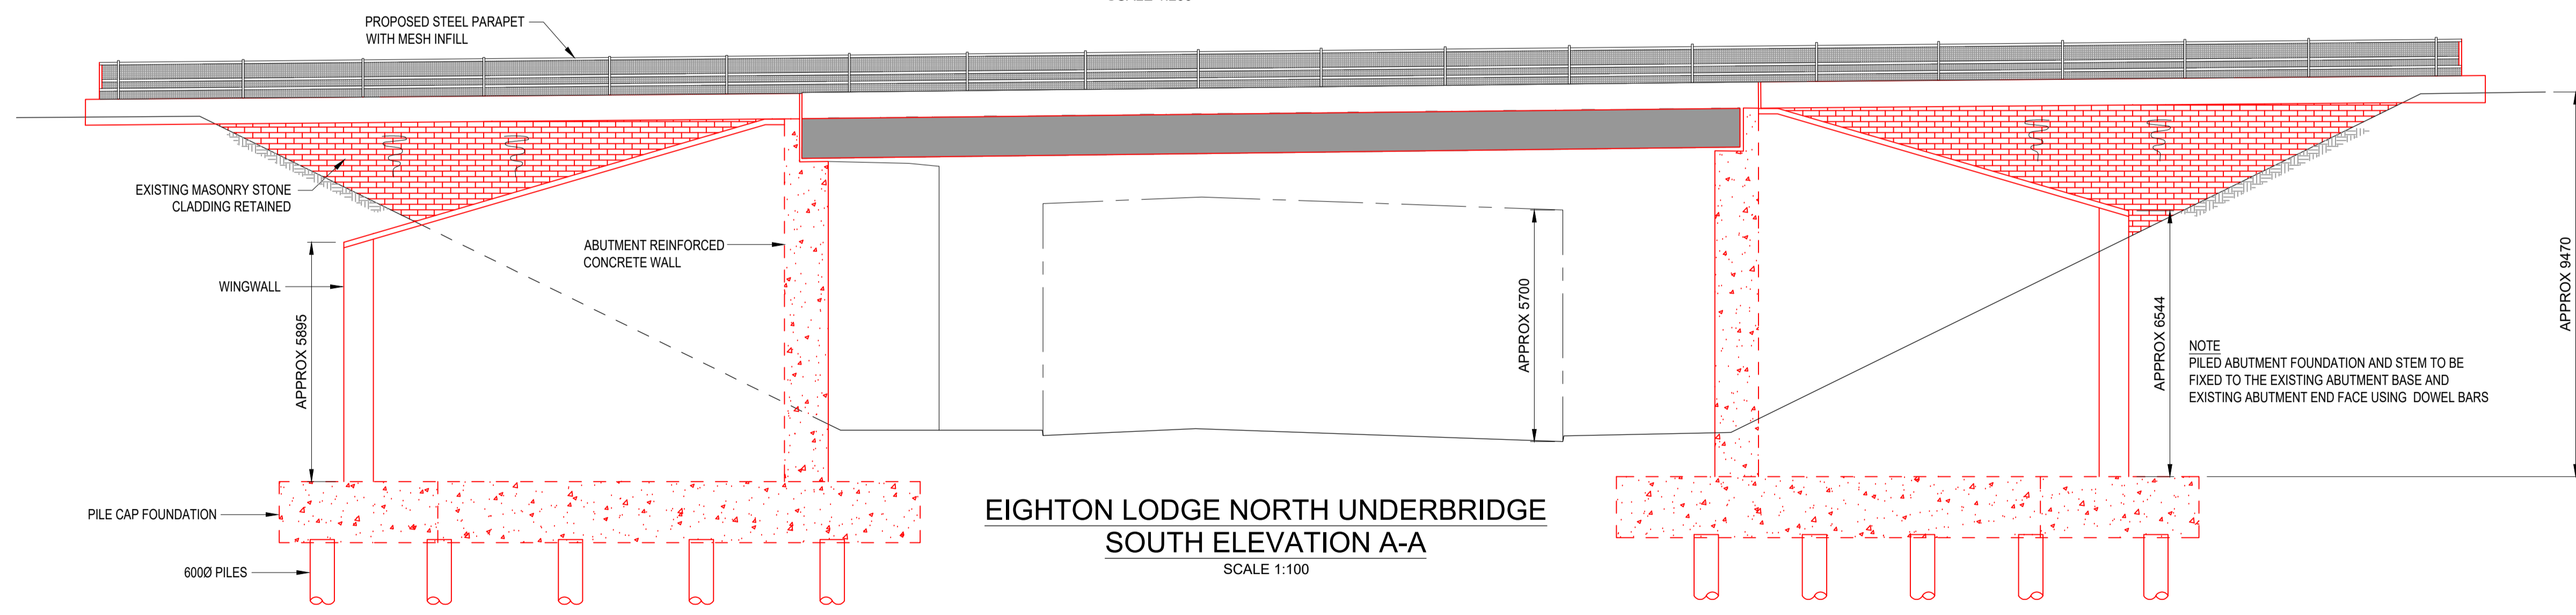

**EIGHTON LODGE NORTH UNDERBRIDGE
SOUTH ELEVATION A-A**
SCALE 1:100

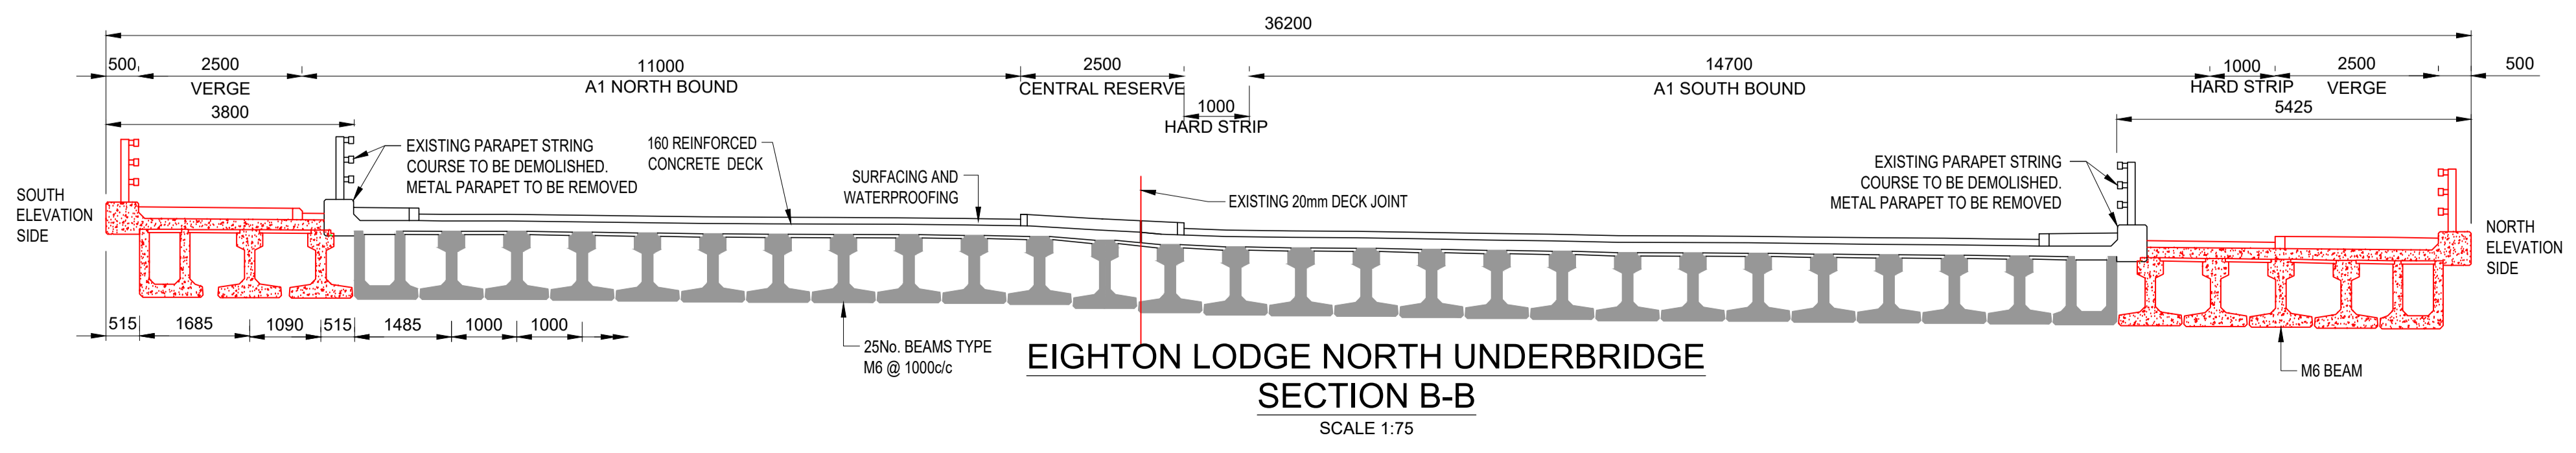

**EIGHTON LODGE NORTH UNDERBRIDGE
SECTION B-B**
SCALE 1:75

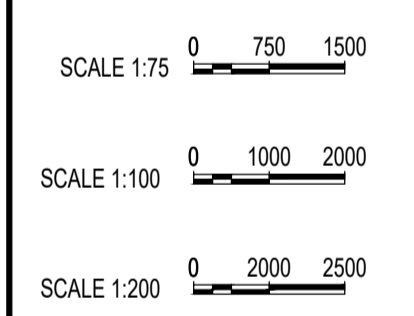

NOTE
PILED ABUTMENT FOUNDATION AND STEM TO BE
FIXED TO THE EXISTING ABUTMENT BASE AND
EXISTING ABUTMENT END FACE USING DOWEL BARS

Rev.	Date	Description	By	Eng' Chk	Disc' Chk	App'd	Status
1	25/02/20	For Examination Deadline 2		RA	IA	IA	NR
0	27/09/19	For Application		RA	IA	IA	NR

For Examination Deadline 2 A3

PINS Reference Number TR010031/APP/2.7(H)



Project Title A1 BIRTLEY TO COAL HOUSE

Drawing Title
**STRUCTURES ENGINEERING DRAWINGS
& SECTIONS REGULATION 5(2)(o)
EIGHTON LODGE NORTH UNDERBRIDGE
(SHEET 7 OF 14)**

Scale	Drawn	Eng. Check	Approved	Authorised
N/A	R.Ayre	I.Akram	I.Akram	N.Rawcliffe


Original Size	Date	Date	Date	Date
A1	25/02/20	25/02/20	25/02/20	25/02/20

HE551462 WSP LSI 1
ZZ DR ZL 45016 3


Confidential

NOTES:


1. ALL DIMENSION ARE IN MILLIMETRES UNLESS NOTED OTHERWISE.
2. ALL LEVELS AND CHAINAGES ARE IN METRES UNLESS NOTED OTHERWISE.
3. DO NOT SCALE. IN CASE OF DOUBTS, OMISSIONS OR ERRORS SEEK CLARIFICATION FROM THE DESIGNER.

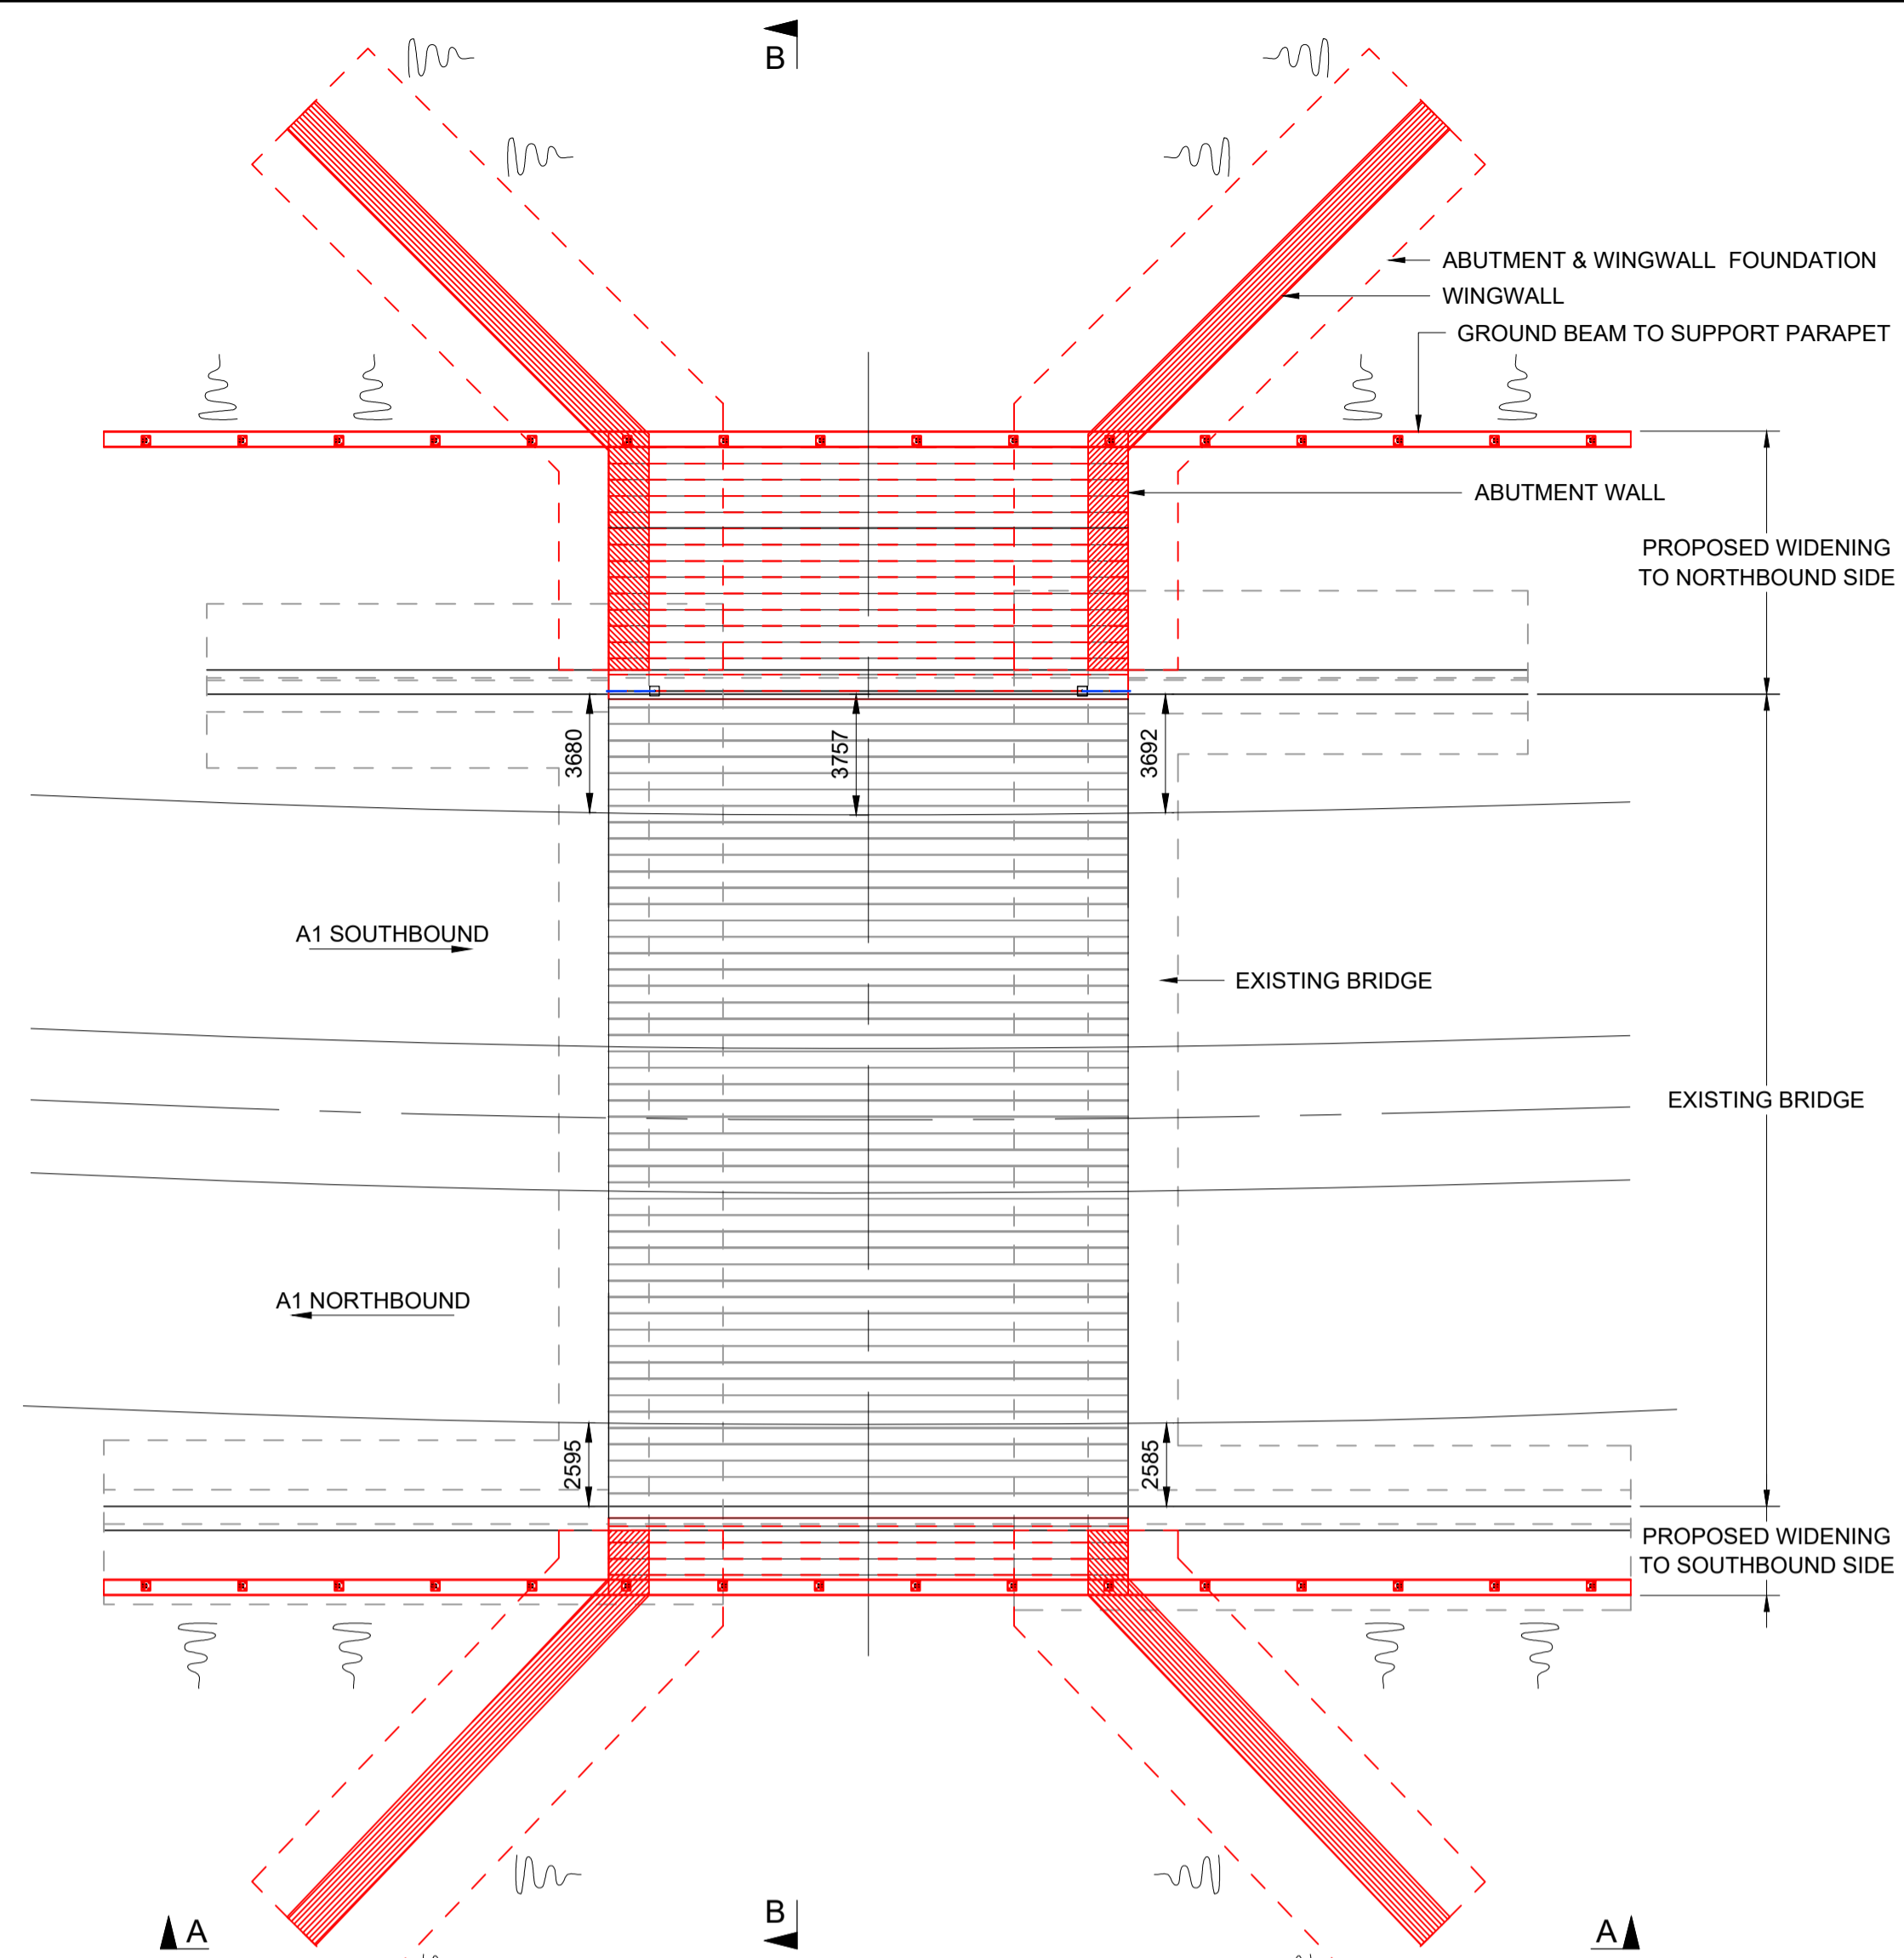


**EIGHTON LODGE SOUTH UNDERBRIDGE
PLAN ON DECK**
SCALE 1:200

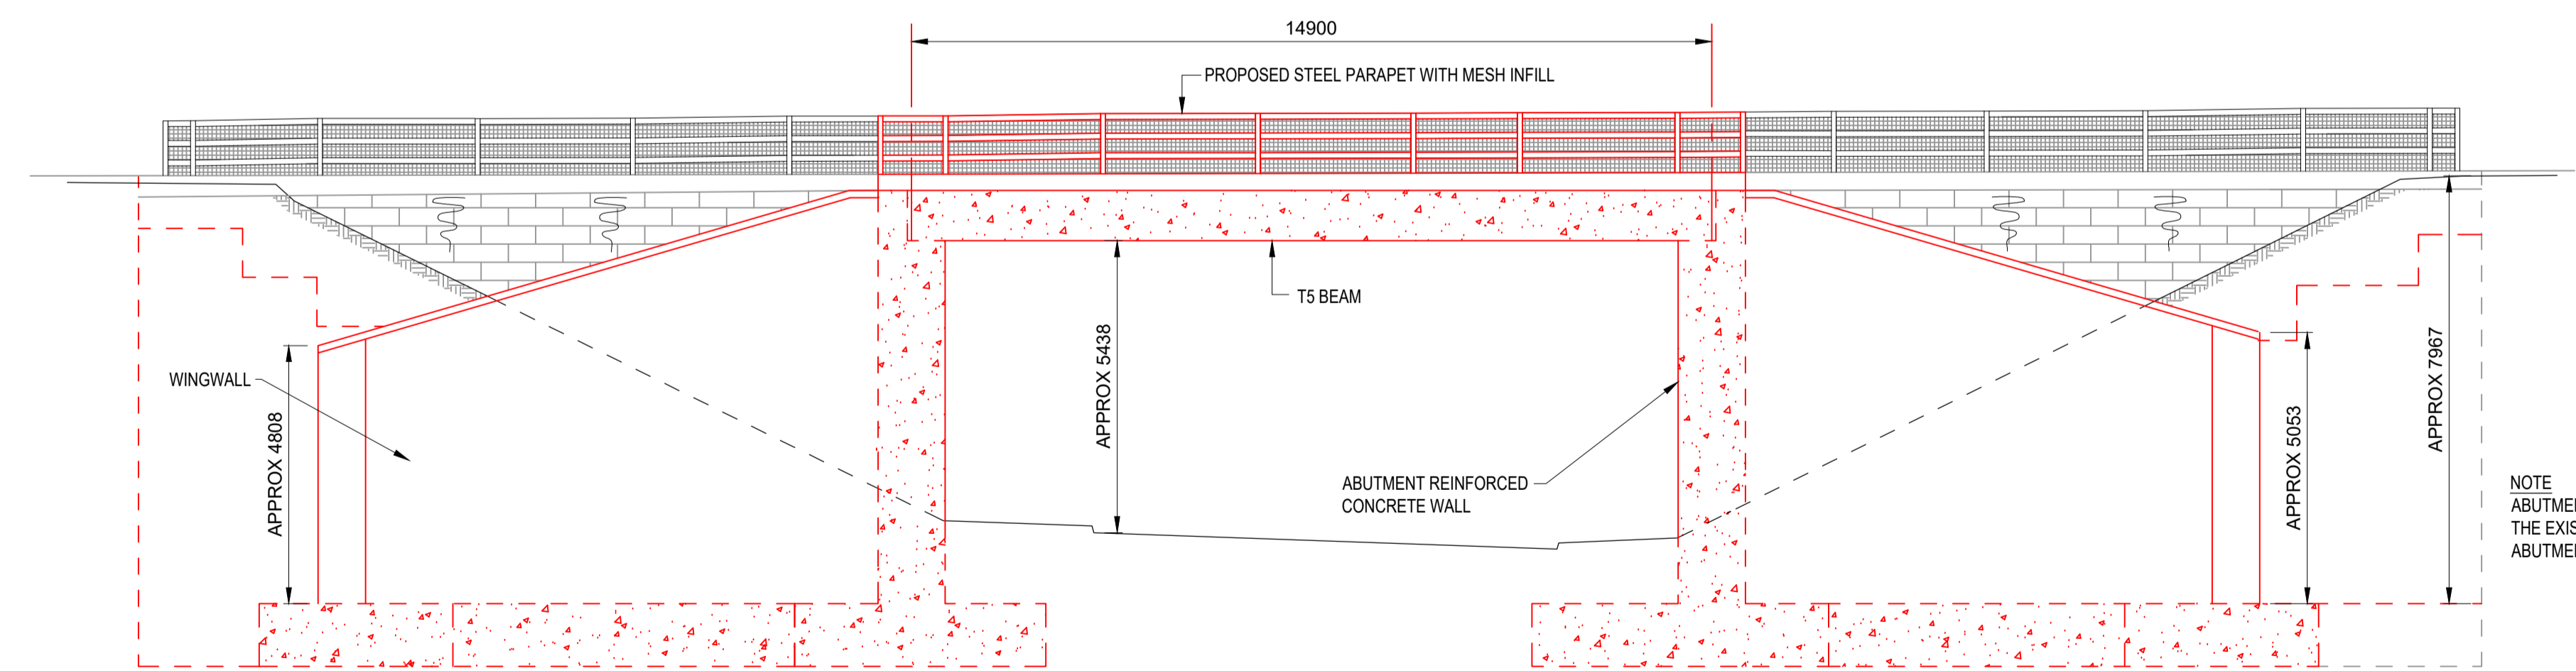

**EIGHTON LODGE SOUTH UNDERBRIDGE
SOUTH ELEVATION A-A**
SCALE 1:100

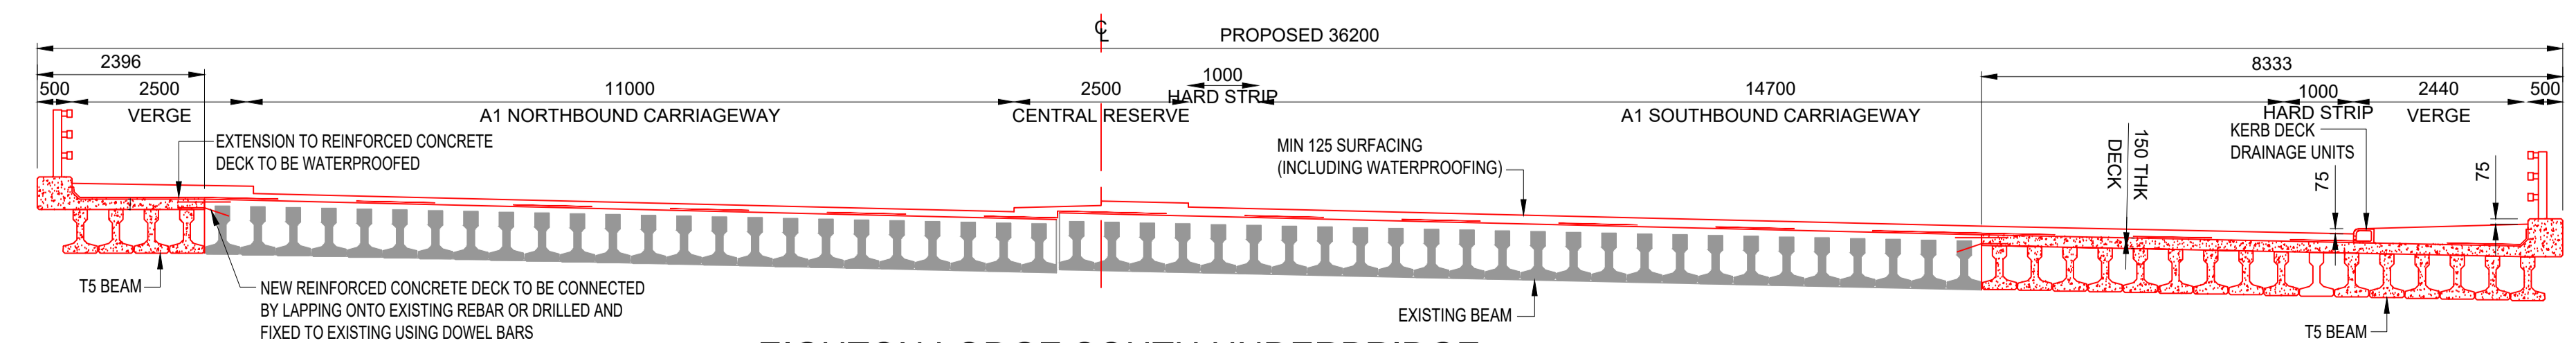

**EIGHTON LODGE SOUTH UNDERBRIDGE
SECTION B-B**
SCALE 1:75

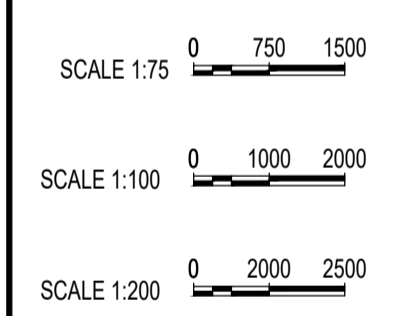

Rev.	Date	Description	By	Eng' Chk	Disc' Chk	App'd	Status
1	25/02/20	For Examination Deadline 2		RA	IA	IA	NR
0	27/09/19	For Application		RA	IA	IA	NR

For Examination Deadline 2 A3

PINS Reference Number **TR010031/APP/2.7(I)**



Project Title **A1 BIRTLEY TO COAL HOUSE**

Drawing Title **STRUCTURES ENGINEERING DRAWINGS & SECTIONS REGULATION 5(2)(o)
EIGHTON LODGE SOUTH UNDERBRIDGE
(SHEET 8 OF 14)**

Scale	Drawn	Eng. Check	Approved	Authorised
N/A	R.Ayre	I.Akram	I.Akram	N.Rawcliffe

Original Size	Date	Date	Date	Date
A1	25/02/20	25/02/20	25/02/20	25/02/20

Drawing Number	Originator	Volume	Revision
HE551462	WSP	LSI	1

Section	Type	ID	Direction	Type	Role	Number
ZZ			DR	ZL	45017	3

Confidential

NOTES:

1. ALL DIMENSION ARE IN MILLIMETRES UNLESS NOTED OTHERWISE.
2. ALL LEVELS AND CHAINAGES ARE IN METRES UNLESS NOTED OTHERWISE.
3. DO NOT SCALE. IN CASE OF DOUBTS, OMISSIONS OR ERRORS SEEK CLARIFICATION FROM THE DESIGNER.


KEY:

- VRS - VEHICLE RESTRAINT SYSTEM
- CSBS - CORRUGATED STEEL BURIED STRUCTURE
- EXISTING, TO BE REMOVED
- PROPOSED EXTENSION


POSSIBILITY OF EXISTING RETAINING WALL COVERED BY EARTHWORK EMBANKMENT. RECORDS TO BE CHECKED BEFORE WORKS. ⚠



**LONGBANK UNDERPASS
PLAN**
SCALE 1:200

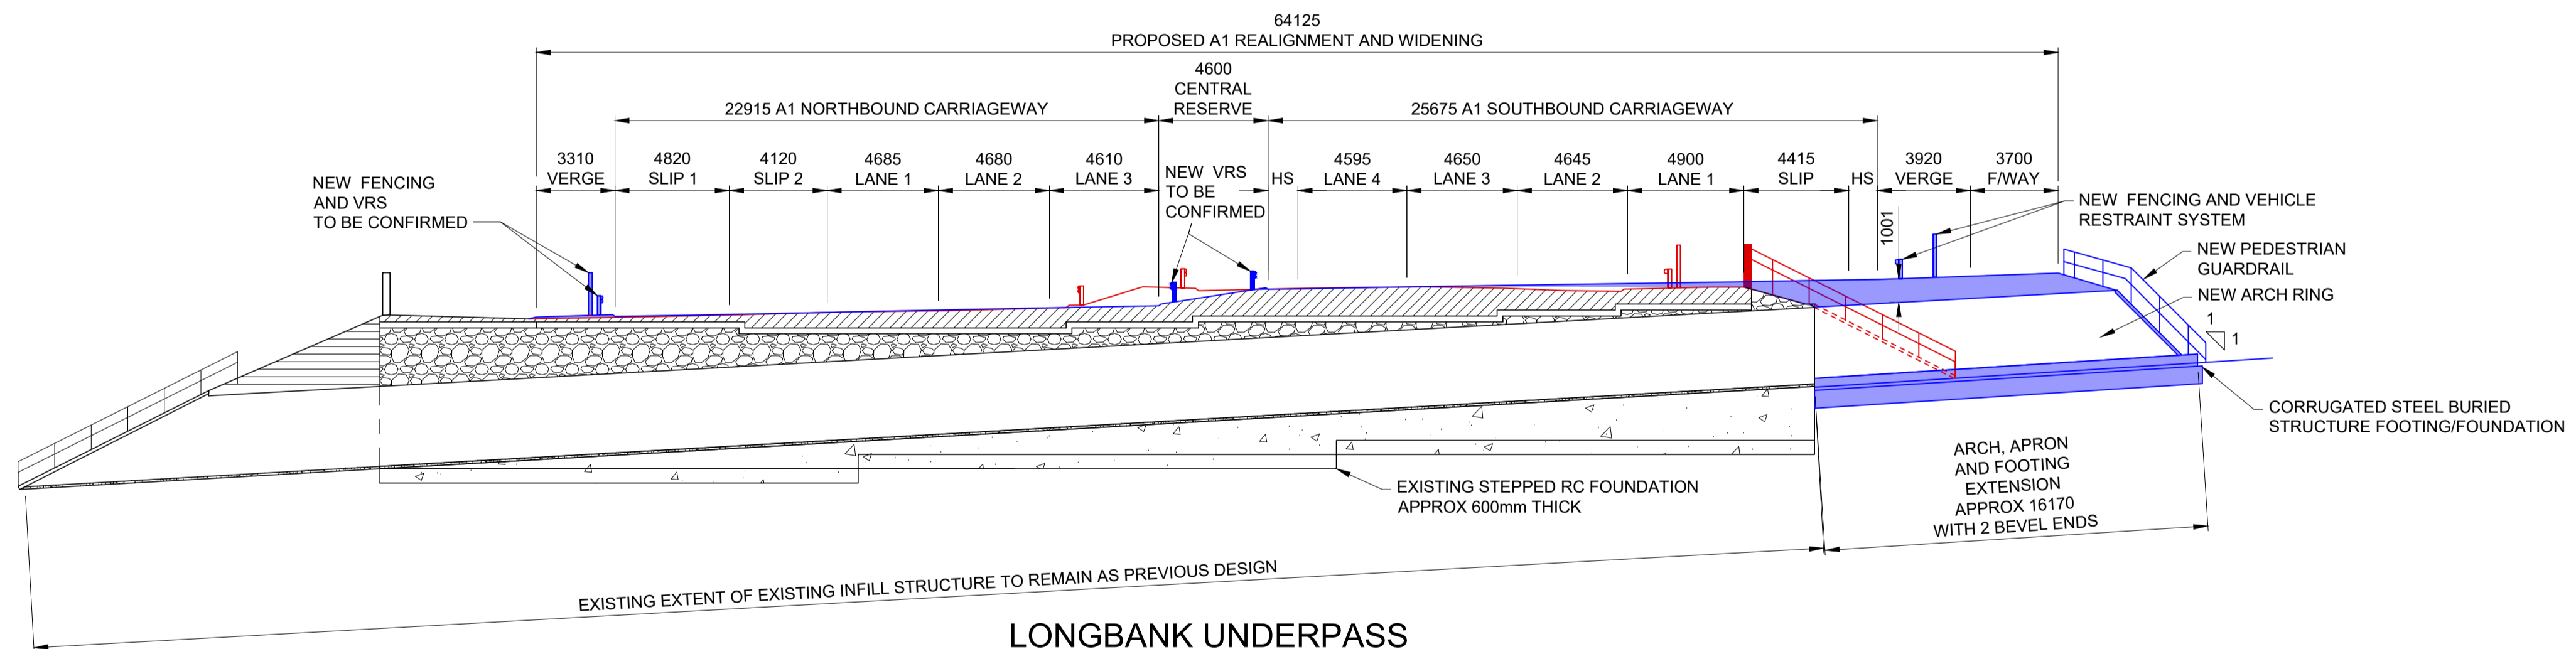

**LONGBANK UNDERPASS
SECTION A-A**
SCALE 1:100

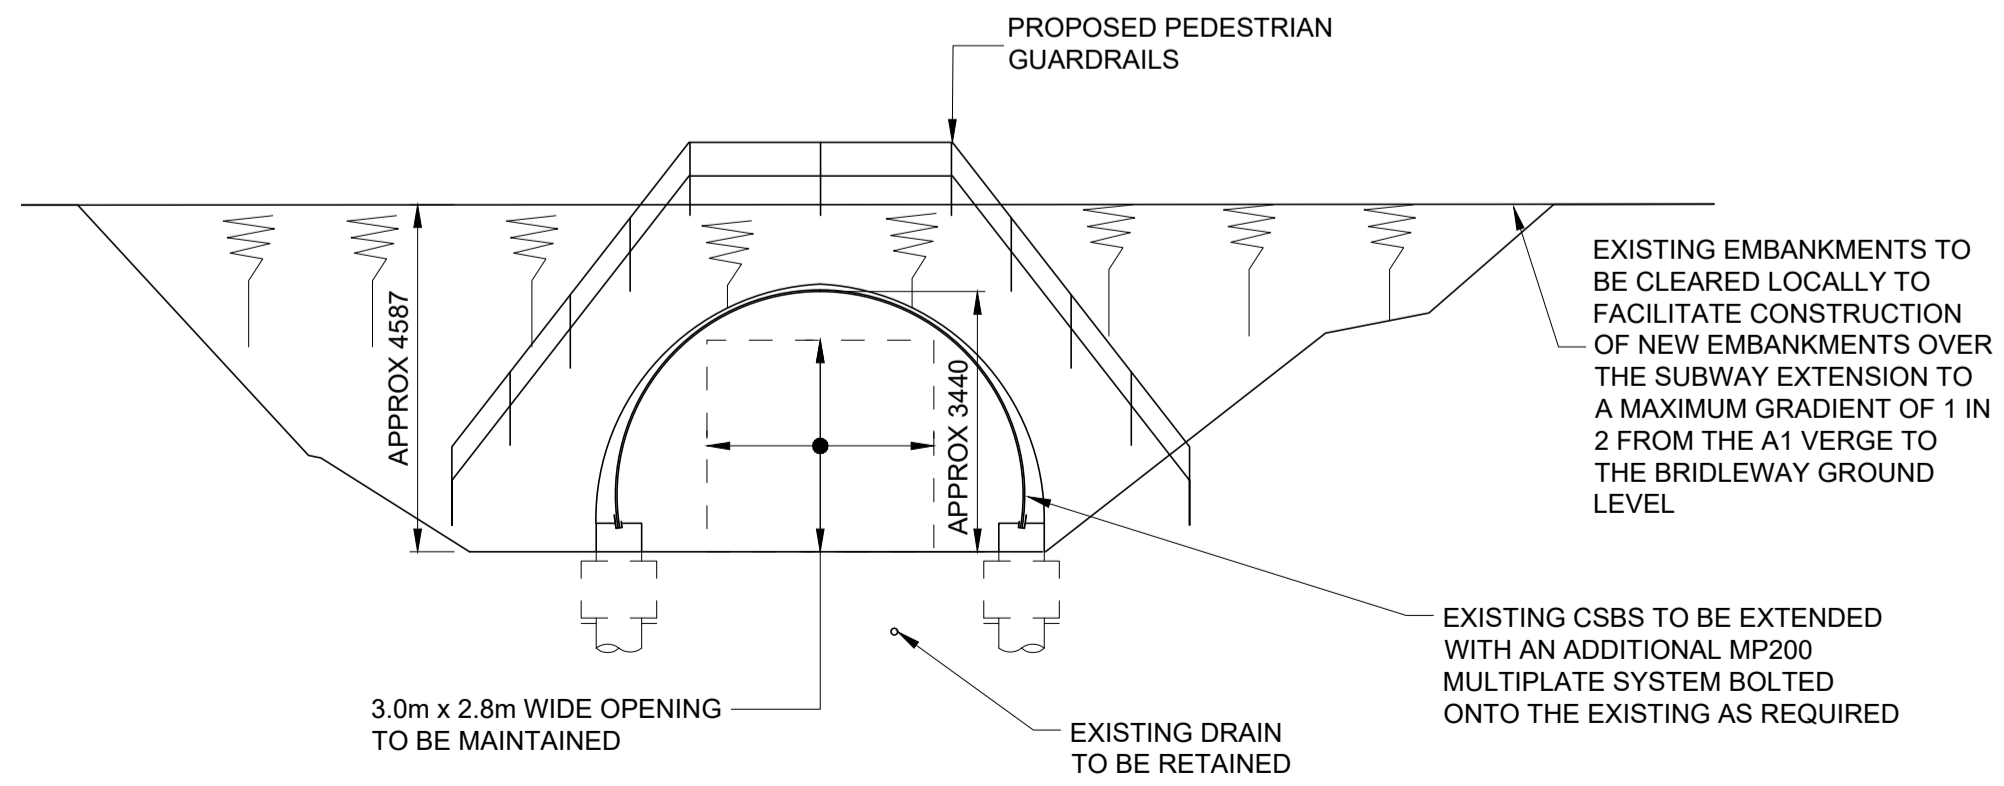

**LONGBANK UNDERPASS
EAST ELEVATION B-B**
SCALE 1:100

SCALE 1:100 0 1000 2000
SCALE 1:200 0 2000 2500

Rev.	Date	Description	By	Eng' Chk	Disc' Chk	App'd	Status
1	25/02/20	For Examination Deadline 2		RA	IA	IA	NR
0	27/09/19	For Application		RA	IA	IA	NR

For Examination Deadline 2 A3

PINS Reference Number **TR010031/APP/2.7(J)**



Client **A1 BIRTLEY TO COAL HOUSE**

Drawing Title
**STRUCTURES ENGINEERING DRAWINGS
& SECTIONS REGULATION 5(2)(o)
LONGBANK UNDERPASS
(SHEET 9 OF 14)**

Scale	Drawn	Eng. Check	Approved	Authorised
N/A	R.Ayre	I.Akram	I.Akram	N.Rawcliffe

Original Size	Date	Date	Date	Date
A1	25/02/20	25/02/20	25/02/20	25/02/20


Confidential

NOTES:

1. ALL DIMENSION ARE IN MILLIMETRES UNLESS NOTED OTHERWISE.
2. ALL LEVELS AND CHAINAGES ARE IN METRES UNLESS NOTED OTHERWISE.
3. DO NOT SCALE. IN CASE OF DOUBTS, OMISSIONS OR ERRORS SEEK CLARIFICATION FROM THE DESIGNER.

KEY:

EXISTING FOOTBRIDGE TO BE REPLACED

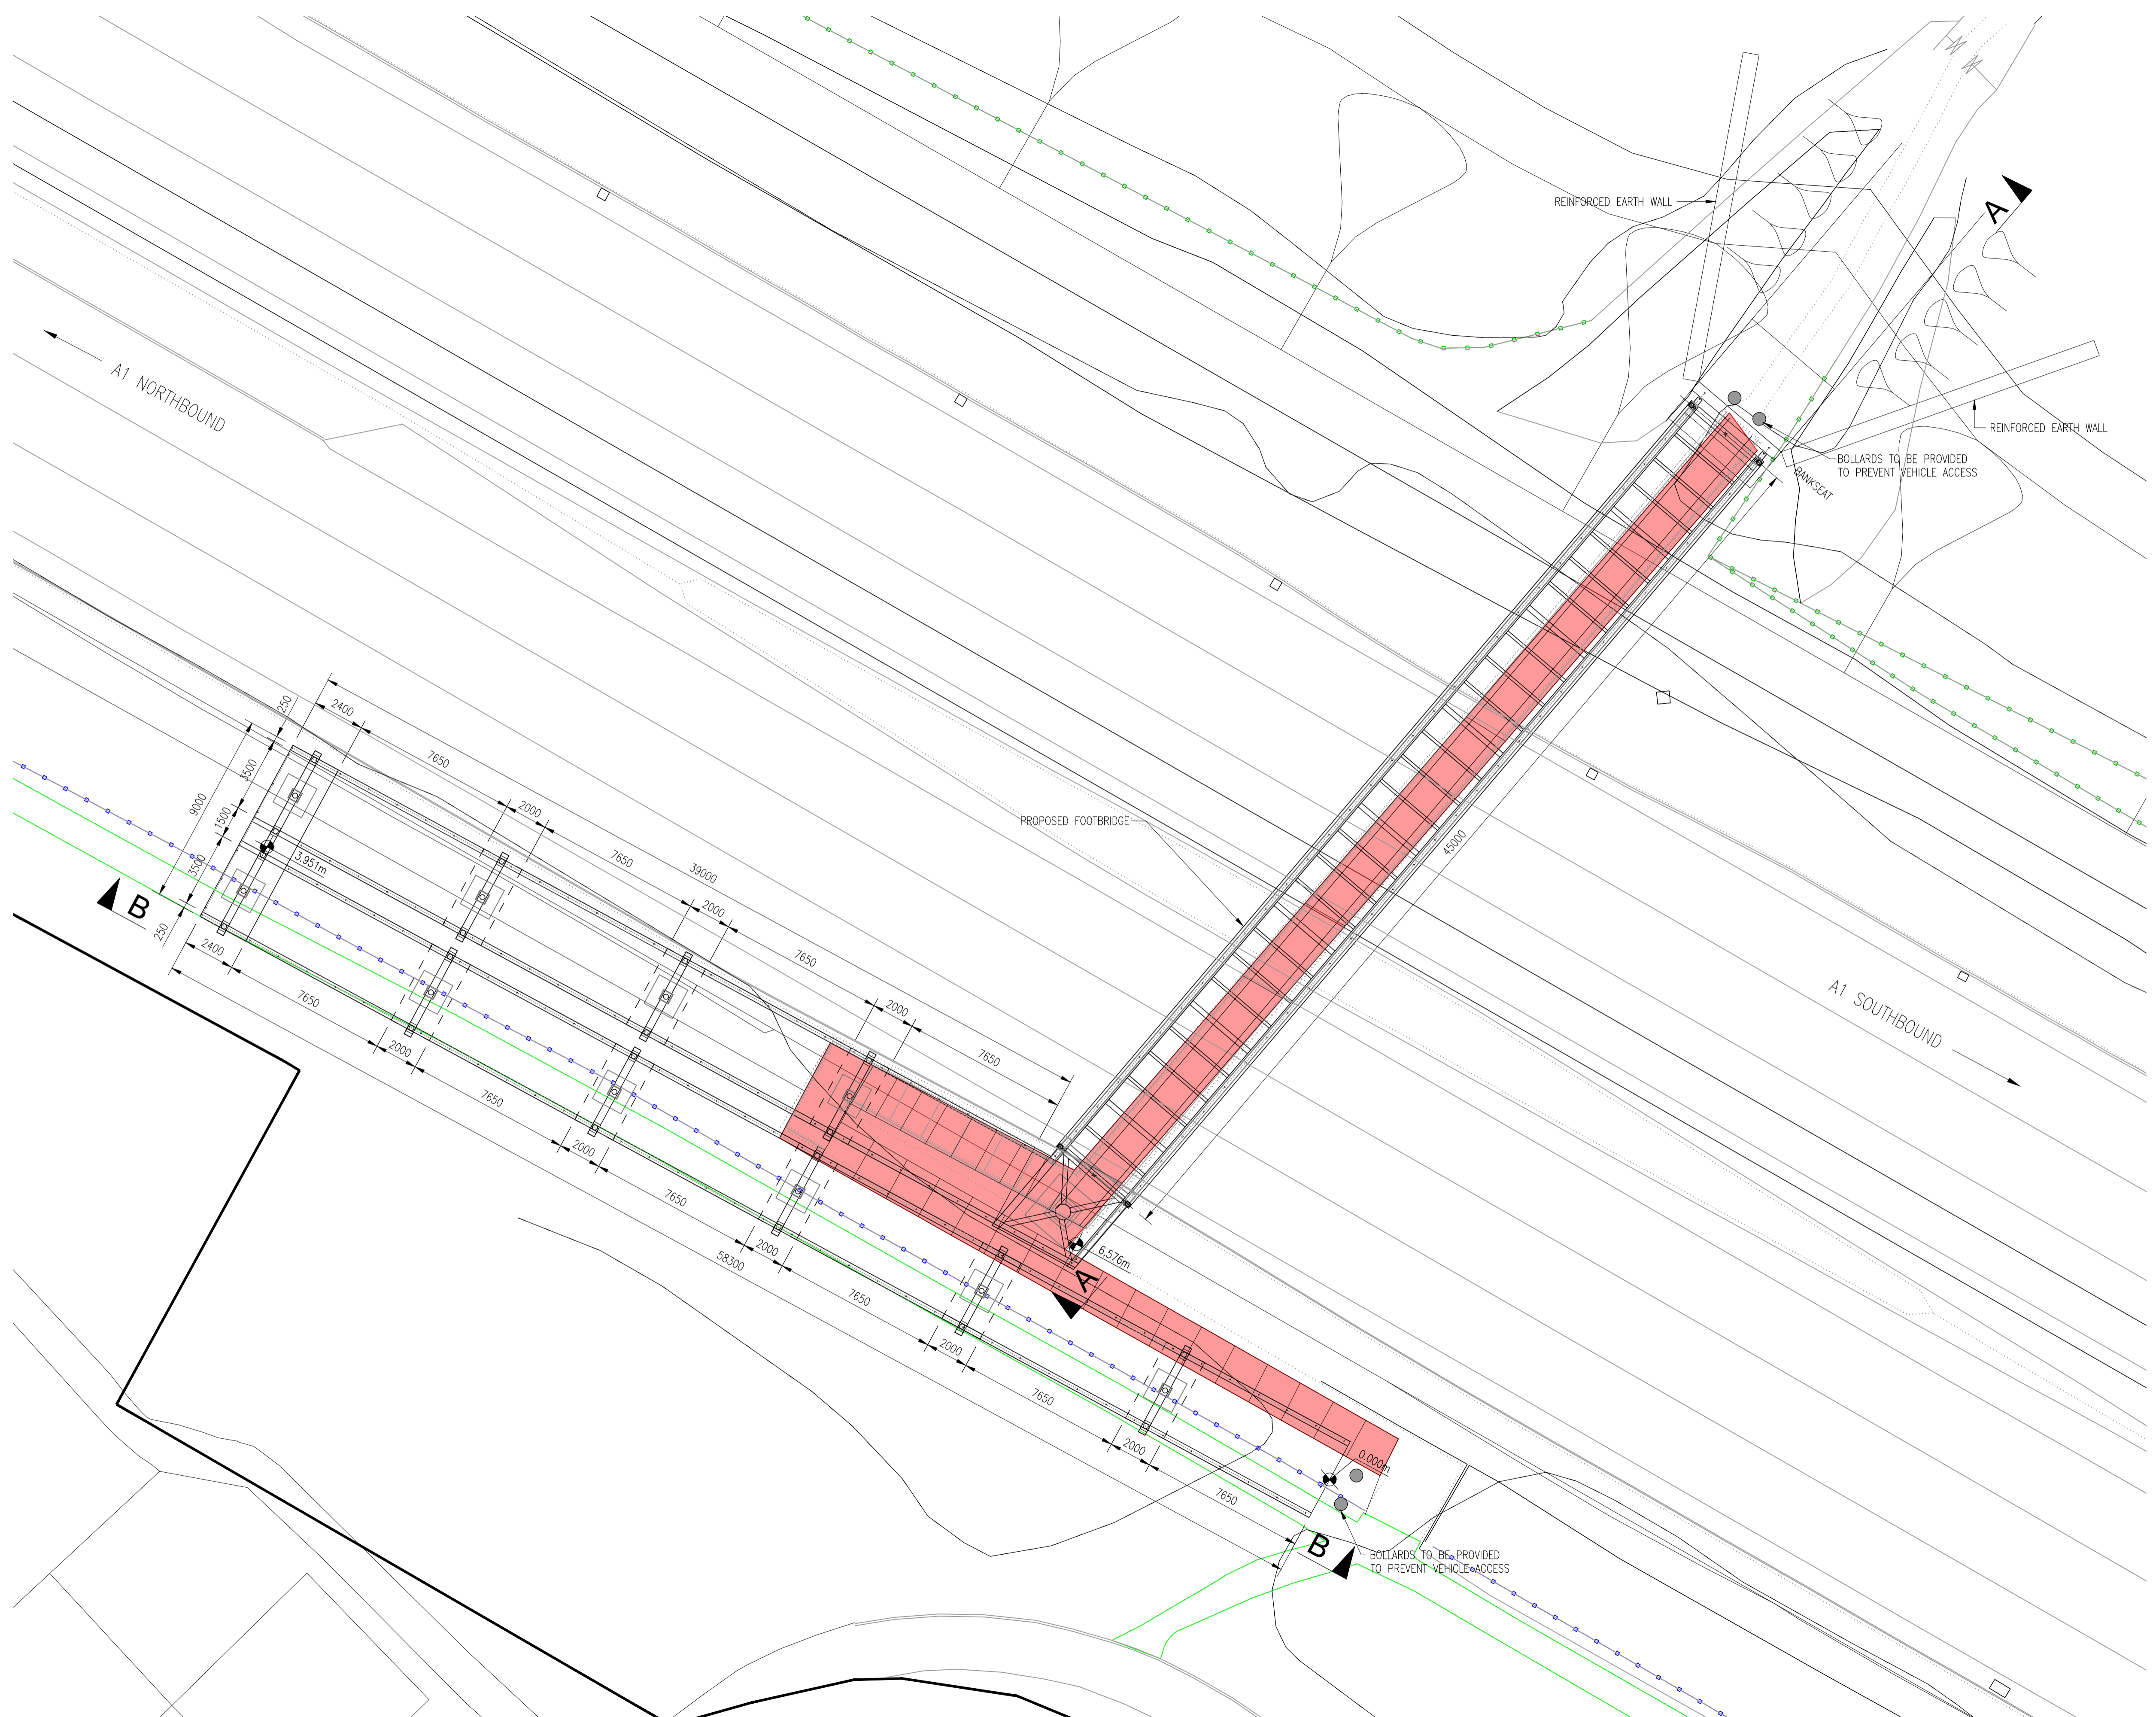

NORTH DENE FOOTBRIDGE (GRADIENT 1:12)

PLAN
SCALE 1:150

SCALE 1:150
0 1500 3000

1	25/02/20	For Examination Deadline 2		RA	IA	IA	NR
0	27/09/19	For Application		RA	IA	IA	NR
Rev.	Date	Description	By	Eng' Chk	Disc' Chk	App'd	Status

For Examination Deadline 2 A3

PINS Reference Number TR010031/APP/2.7(K)



Client A1 BIRTLEY TO COAL HOUSE

Drawing Title
STRUCTURES ENGINEERING DRAWINGS & SECTIONS REGULATION 5(2)(o)
NORTH DENE FOOTBRIDGE
(SHEET 10 OF 14)

Scale	N/A	Drawn	R.Ayre	Eng. Check	I.Akram	Approved	I.Akram	Authorised	N.Rawcliffe
Original Size	A1	Date	25/02/20	Date	25/02/20	Date	25/02/20	Date	25/02/20

Drawing Number	HE551462	Originator	WSP	Volume	LSI	Revision	1
Section	ZZ	Type	DR	Role	ZL	Number	45019
						PW Stage Code	3


Confidential

1. ALL DIMENSION ARE IN MILLIMETRES UNLESS NOTED OTHERWISE.
2. ALL LEVELS AND CHAINAGES ARE IN METRES UNLESS NOTED OTHERWISE.
3. DO NOT SCALE. IN CASE OF DOUBTS, OMISSIONS OR ERRORS SEEK CLARIFICATION FROM THE DESIGNER.


KEY:
 SHS - SQUARE HOLLOW SECTION
 RHS - RECTANGULAR HOLLOW SECTION
 CHS - CIRCULAR HOLLOW SECTION
 RRRAP - ROAD RESTRAINT RISK ASSESSMENT PROCESS

SOUTH


NORTH

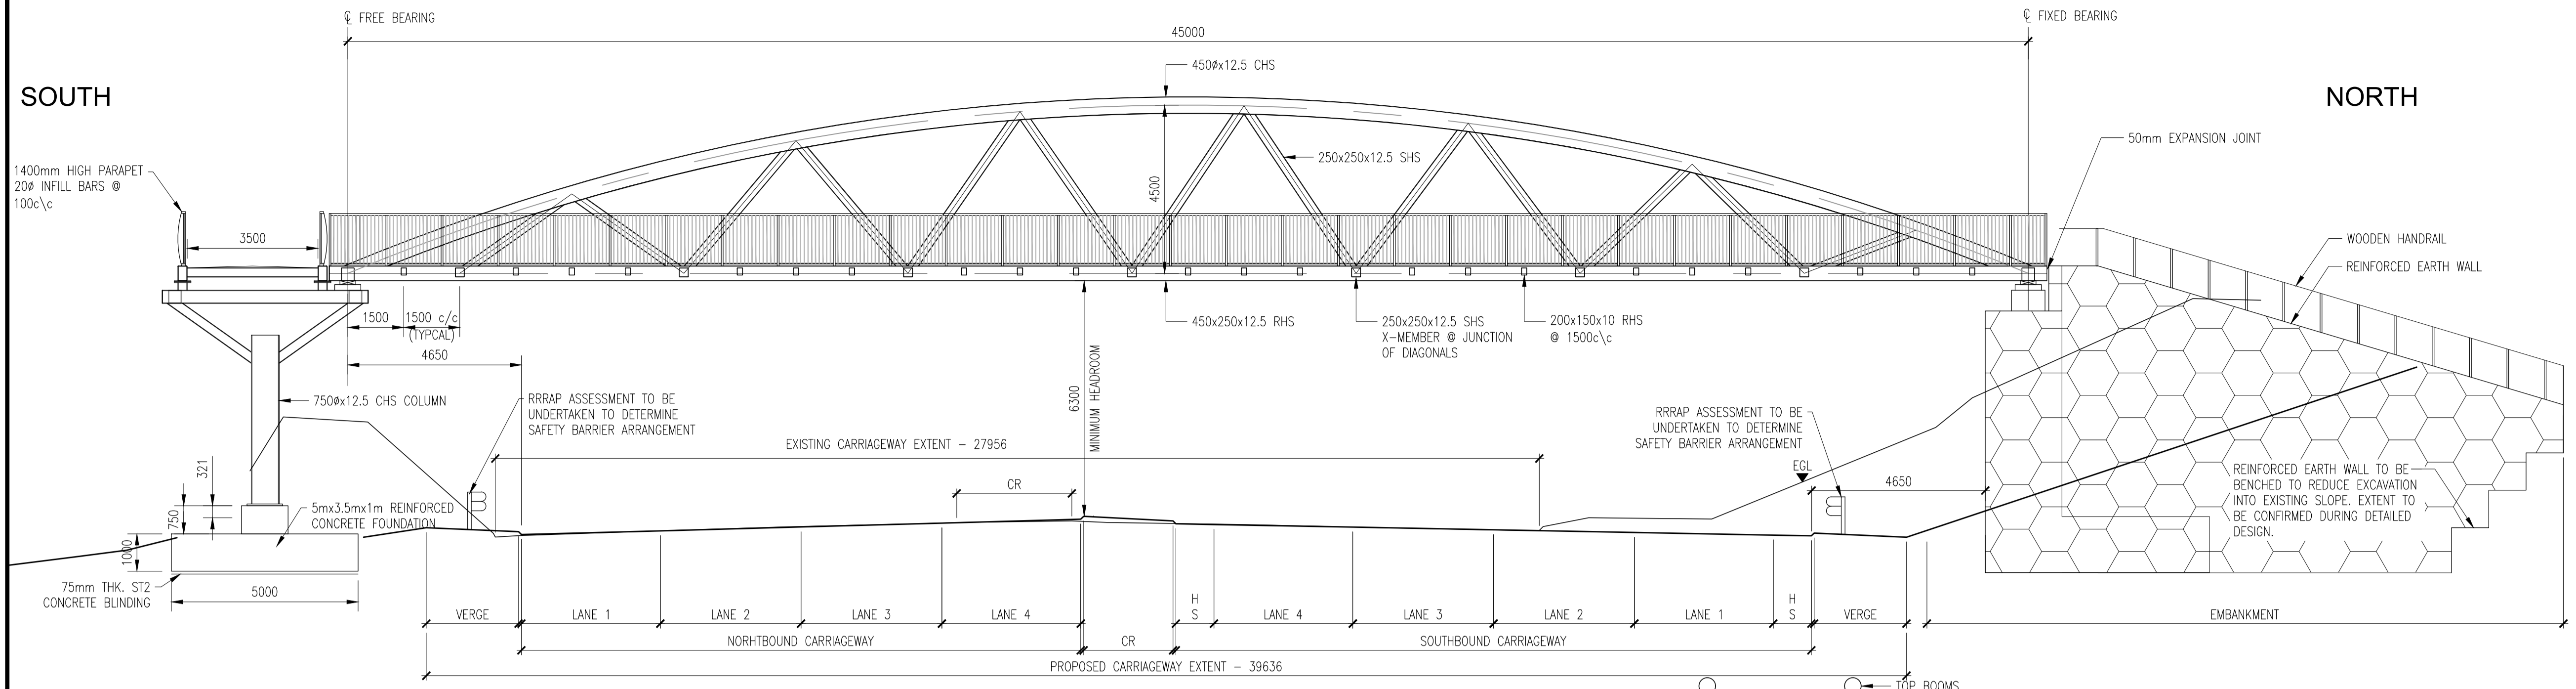


NORTH DENE FOOTBRIDGE - SECTION A-A
 SCALE 1:100

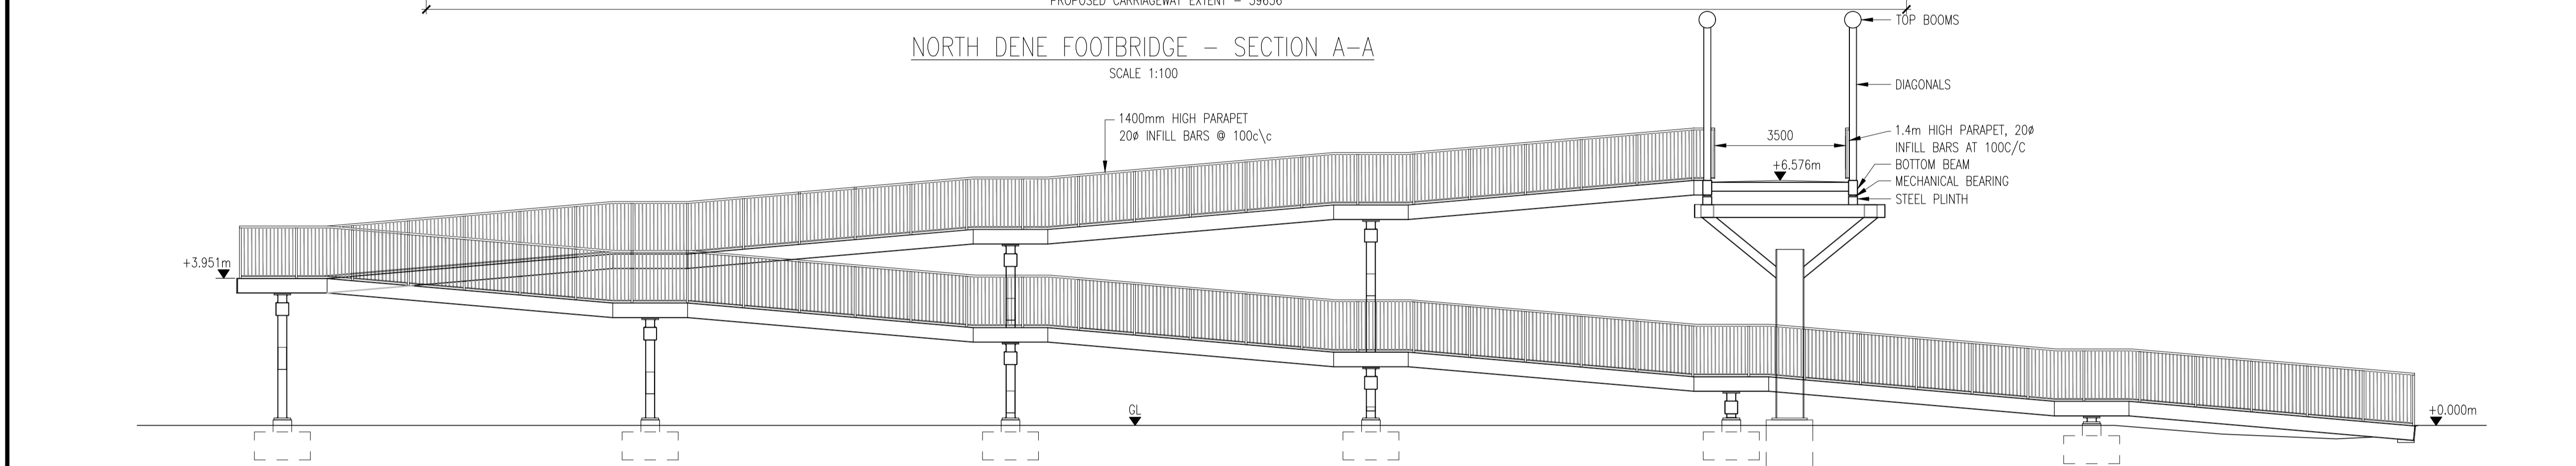

NORTH DENE FOOTBRIDGE - ELEVATION B-B
 SCALE 1:100

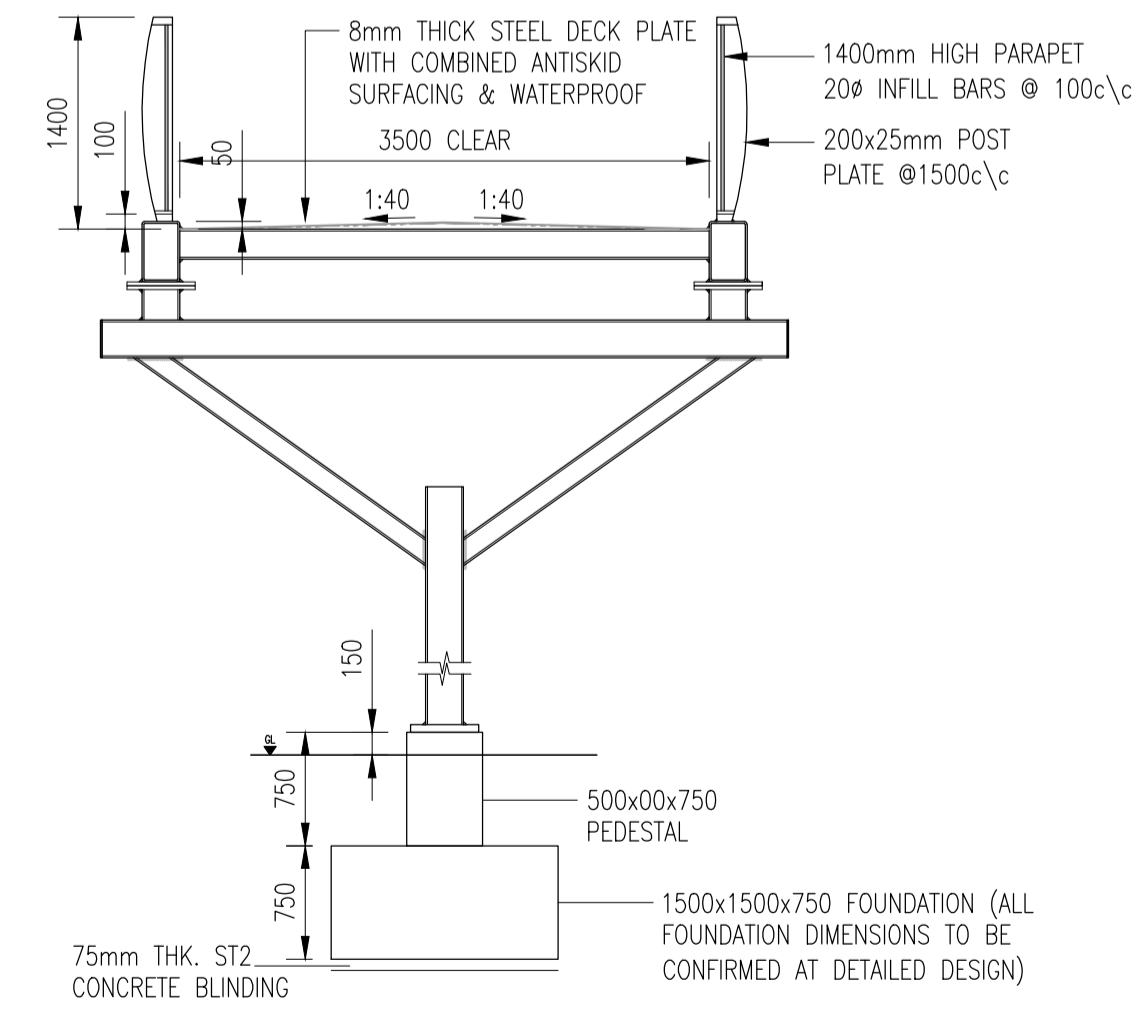

NORTH DENE FOOTBRIDGE - TYPICAL SECTION THROUGH RAMP
 SCALE 1:50

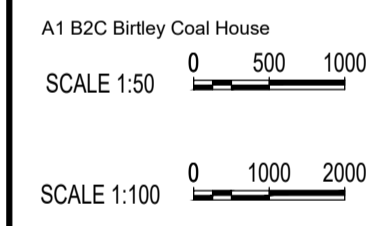

Rev.	Date	Description	By	Eng' Chk	Disc' Chk	App'd	Status
1	25/02/20	For Examination Deadline 2					RA IA IA NR
0	27/09/19	For Application					RA IA IA NR

For Examination Deadline 2 A3

PINS Reference Number TR010031/APP/2.7(L)



Project Title A1 BIRTLEY TO COAL HOUSE

Drawing Title STRUCTURES ENGINEERING DRAWINGS & SECTIONS REGULATION 5(2)(o) NORTH DENE FOOTBRIDGE (SHEET 11 OF 14)

Scale	Drawn	Eng. Check	Approved	Authorised
N/A	R.Ayre	I.Akram	I.Akram	N.Rawcliffe





Original Size	Date	Date	Date	Date
A1	25/02/20	25/02/20	25/02/20	25/02/20

HE551462 WSP LSI 1
 ZZ DR ZL 45020 3

Confidential

NOTES:

1. ALL DIMENSION ARE IN MILLIMETRES UNLESS NOTED OTHERWISE.
2. ALL LEVELS AND CHAINAGES ARE IN METRES UNLESS NOTED OTHERWISE.
3. DO NOT SCALE. IN CASE OF DOUBTS, OMISSIONS OR ERRORS SEEK CLARIFICATION FROM THE DESIGNER.
4. TEXT ON THE GANTRY SIGNS IS INDICATIVE
5. DRAWING APPLICABLE TO GANTRIES SG001 TO SG006 (SEE KEY PLAN DRAWING HE551462-WSP-LSI-ZZ-DR-ZL-45023)

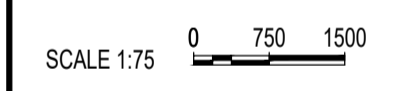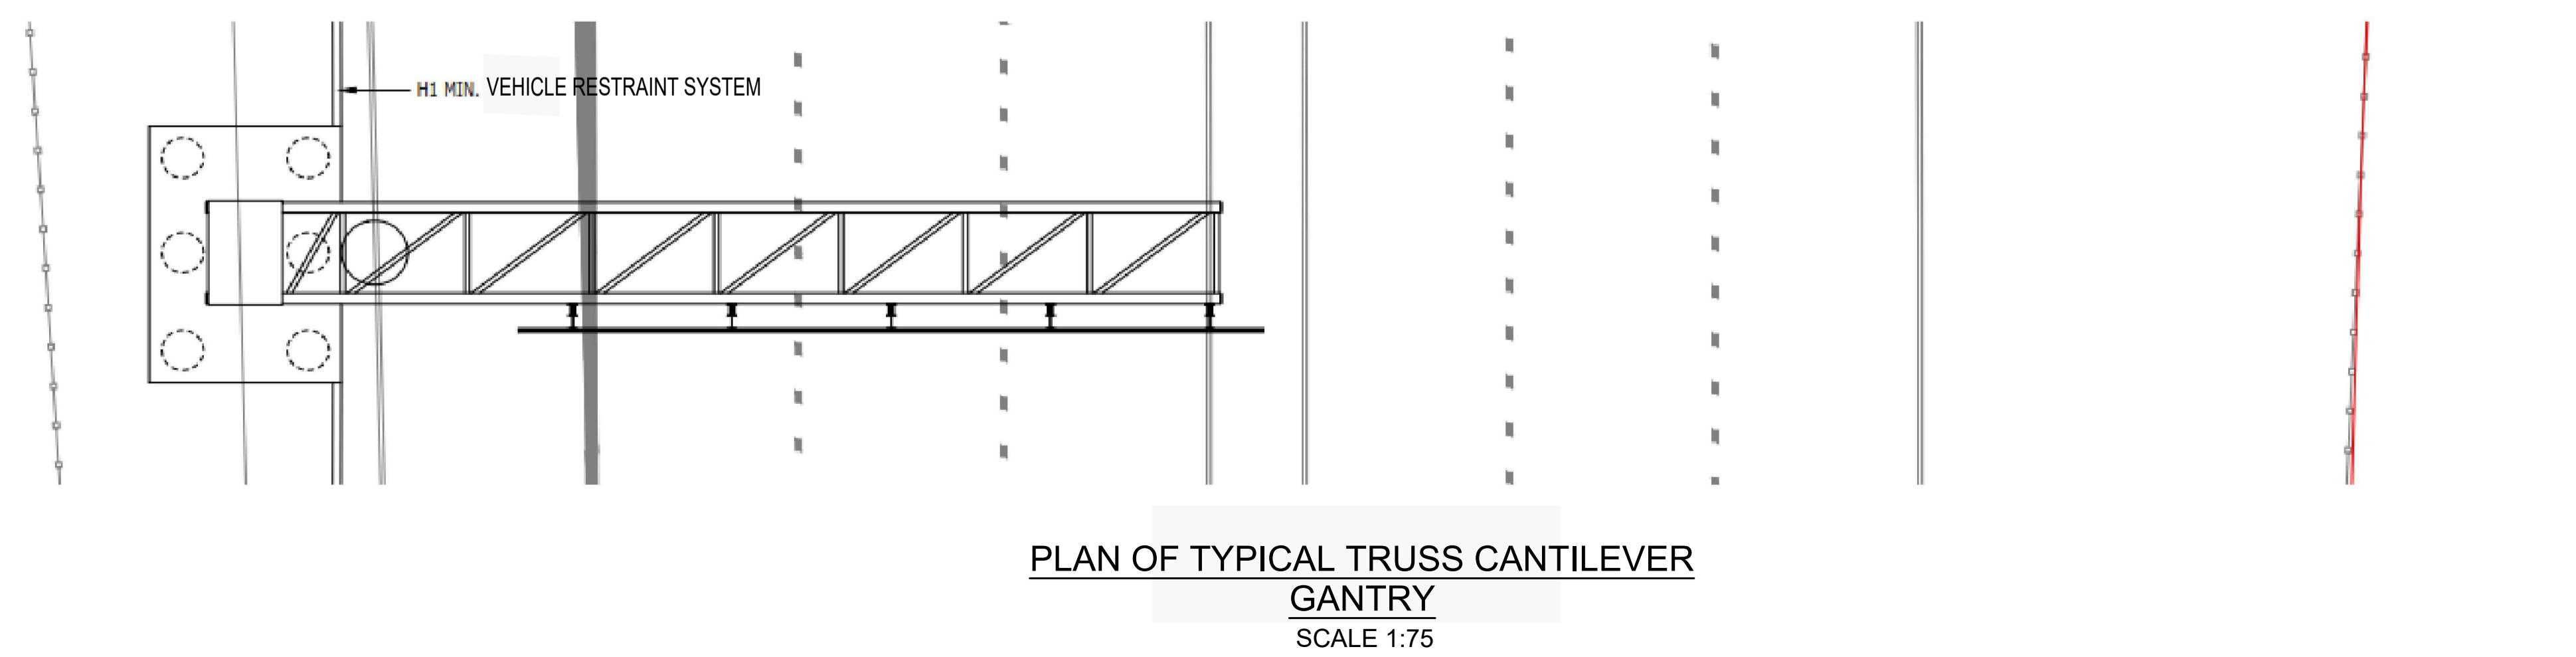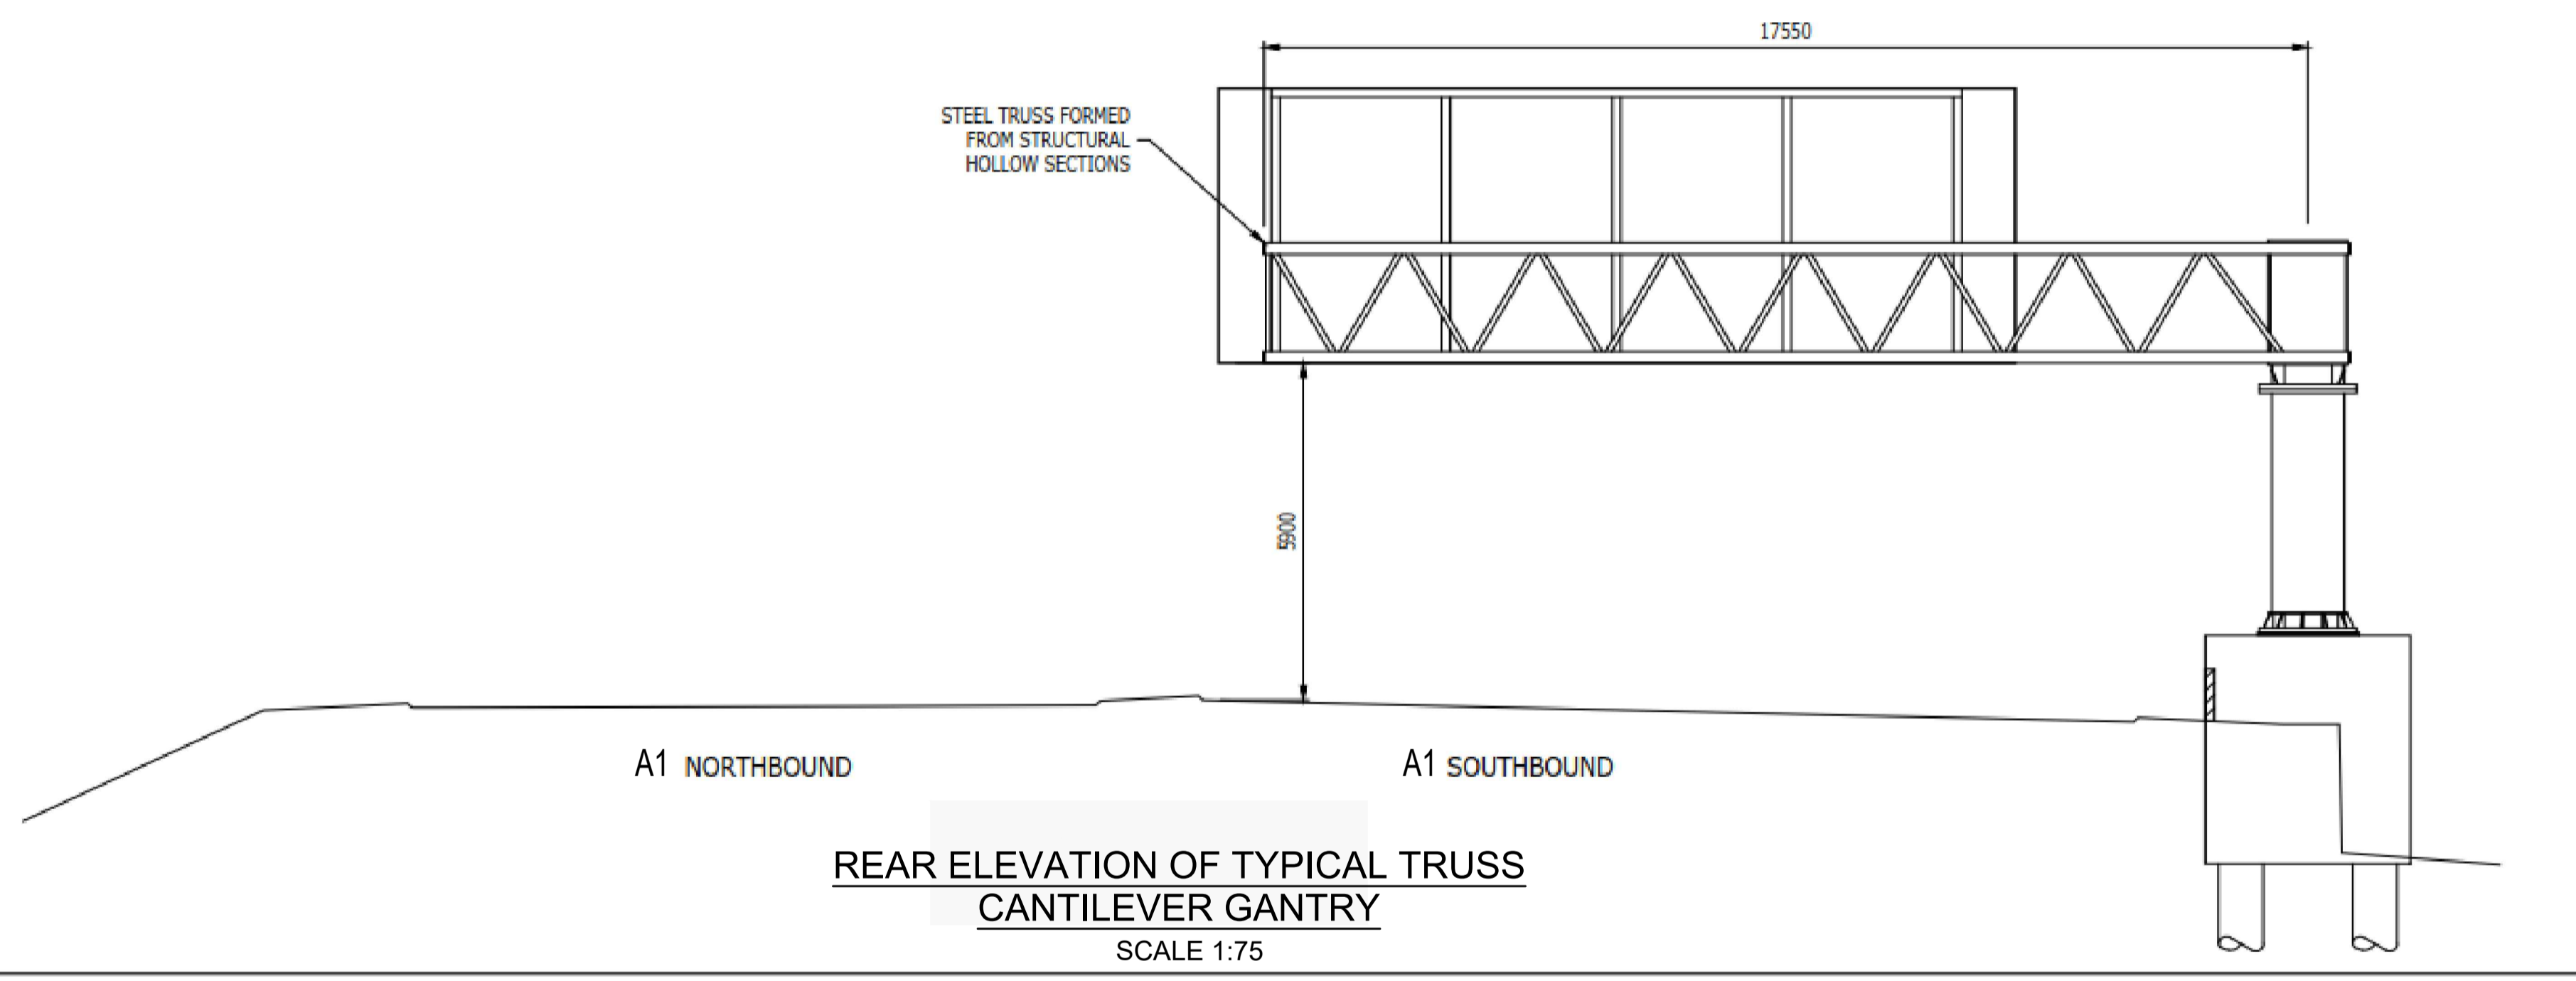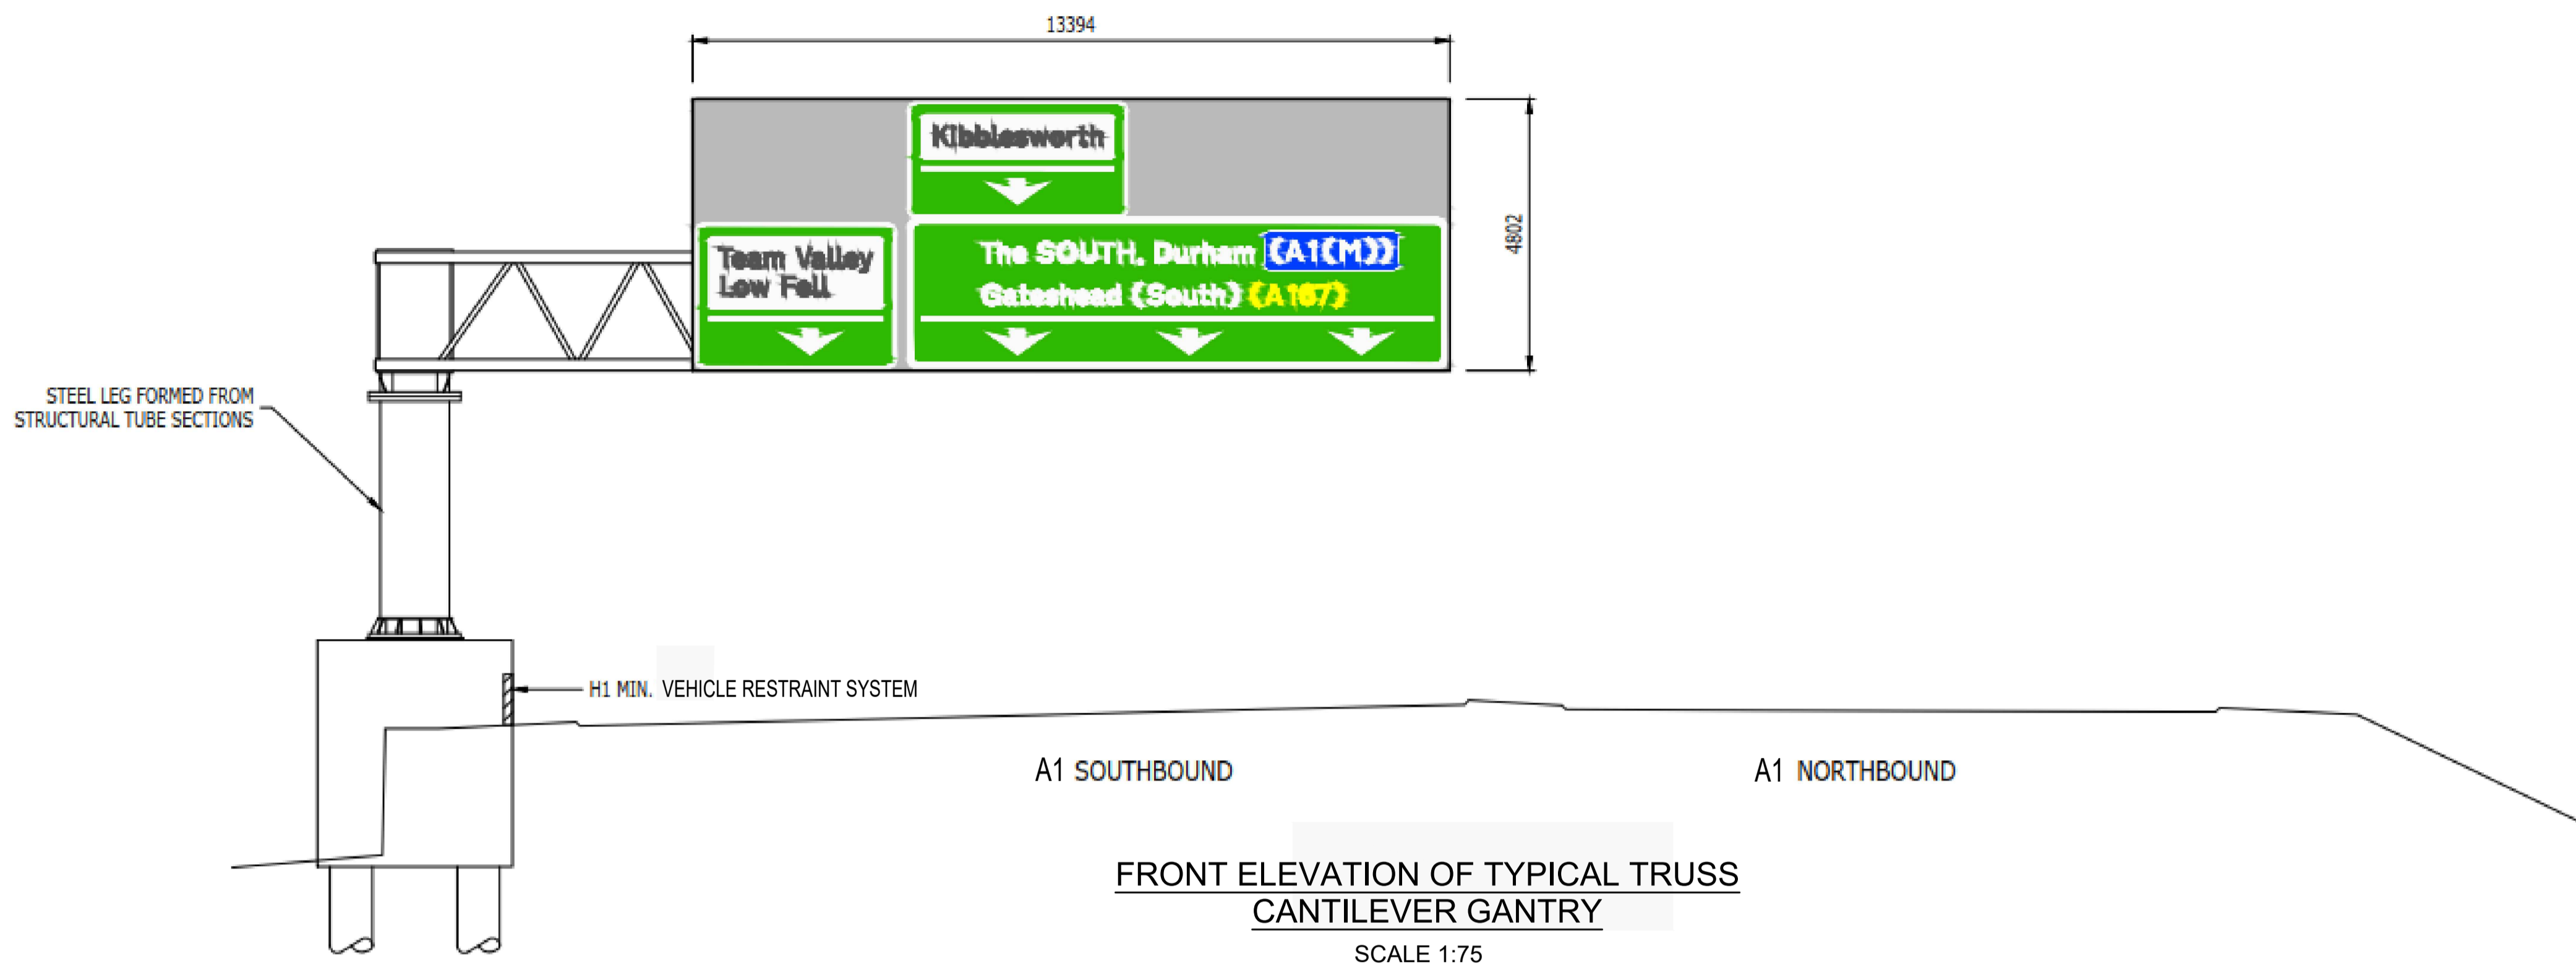

Rev.	Date	Description	By	Eng' Chk	Disc' Chk	App'd	Status
1	25/02/20	For Examination Deadline 2		RA	IA	IA	NR
0	27/09/19	For Application		RA	IA	IA	NR

For Examination Deadline 2 A3

PINS Reference Number TR010031/APP/2.7(M)



Client A1 BIRTLEY TO COAL HOUSE


Drawing Title
STRUCTURES ENGINEERING DRAWINGS & SECTIONS REGULATION 5(2)(o)
TYPICAL ADS GANTRY - TRUSS CANTILEVER TYPE (SHEET 12 OF 14)

Scale	Drawn	Eng. Check	Approved	Authorised
N/A	R.Ayre	I.Akram	I.Akram	N.Rawcliffe
Original Size	Date	Date	Date	Date
A1	25/02/20	25/02/20	25/02/20	25/02/20

Drawing Number	Originator	Volume	Revision
HE551462	WSP	LSI	1
Section	Type	Role	Number
ZZ	DR	ZL	45021
			3


NOTES:

1. ALL DIMENSION ARE IN MILLIMETERS UNLESS NOTED OTHERWISE.
2. ALL LEVELS AND CHAINAGES ARE IN METRES UNLESS NOTED OTHERWISE.
3. DO NOT SCALE. IN CASE OF DOUBTS, OMISSIONS OR ERRORS SEEK CLARIFICATION FROM THE DESIGNER.
4. TEXT ON THE GANTRY SIGNS IS INDICATIVE.
5. DRAWING APPLICABLE TO GANTRIES SG007 TO SG012 (SEE KEY PLAN DRAWING HE551462-WSP-LSI-ZZ-DR-ZL-45023)

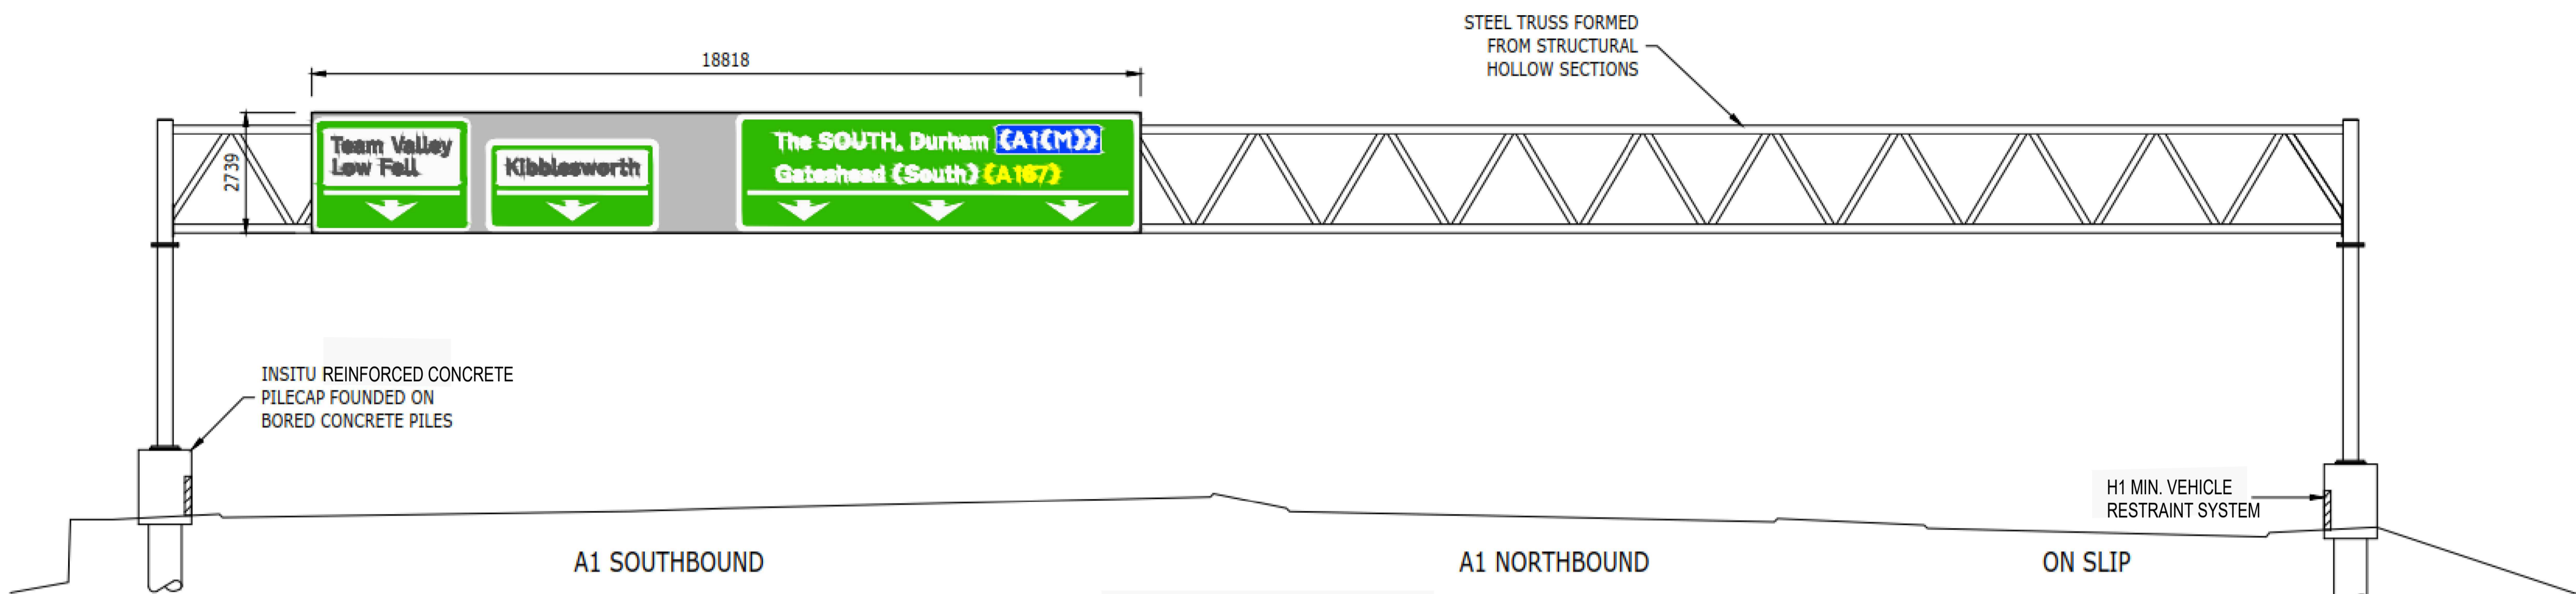


FRONT ELEVATION OF TYPICAL SUPER-SPAN GANTRY

SCALE 1:75

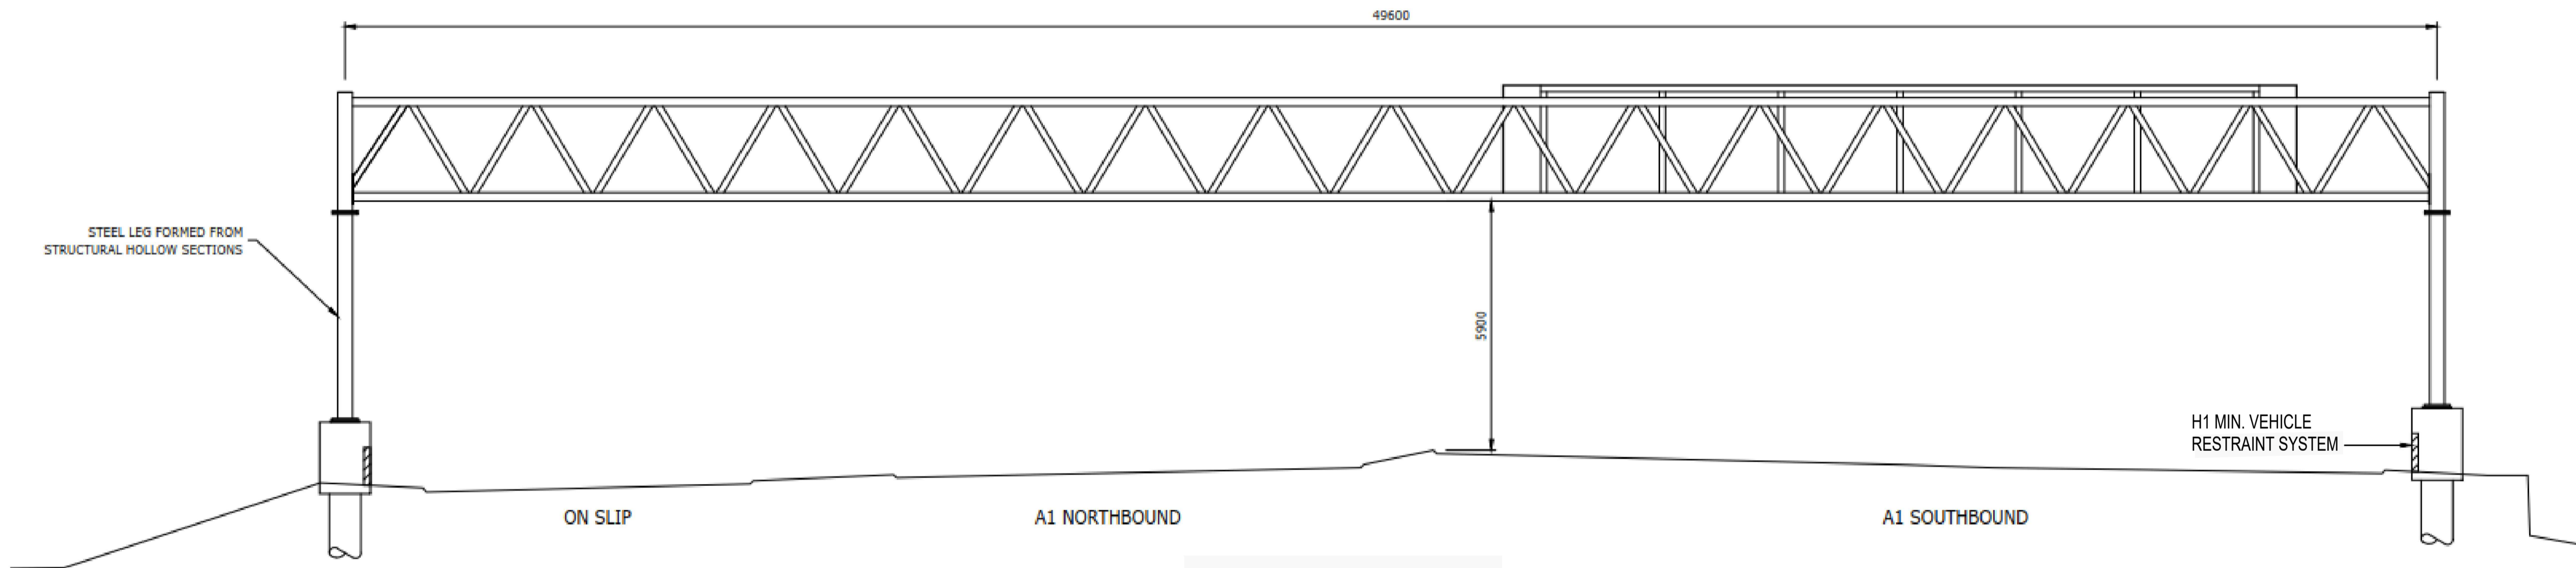

REAR ELEVATION OF TYPICAL SUPER-SPAN GANTRY

SCALE 1:75

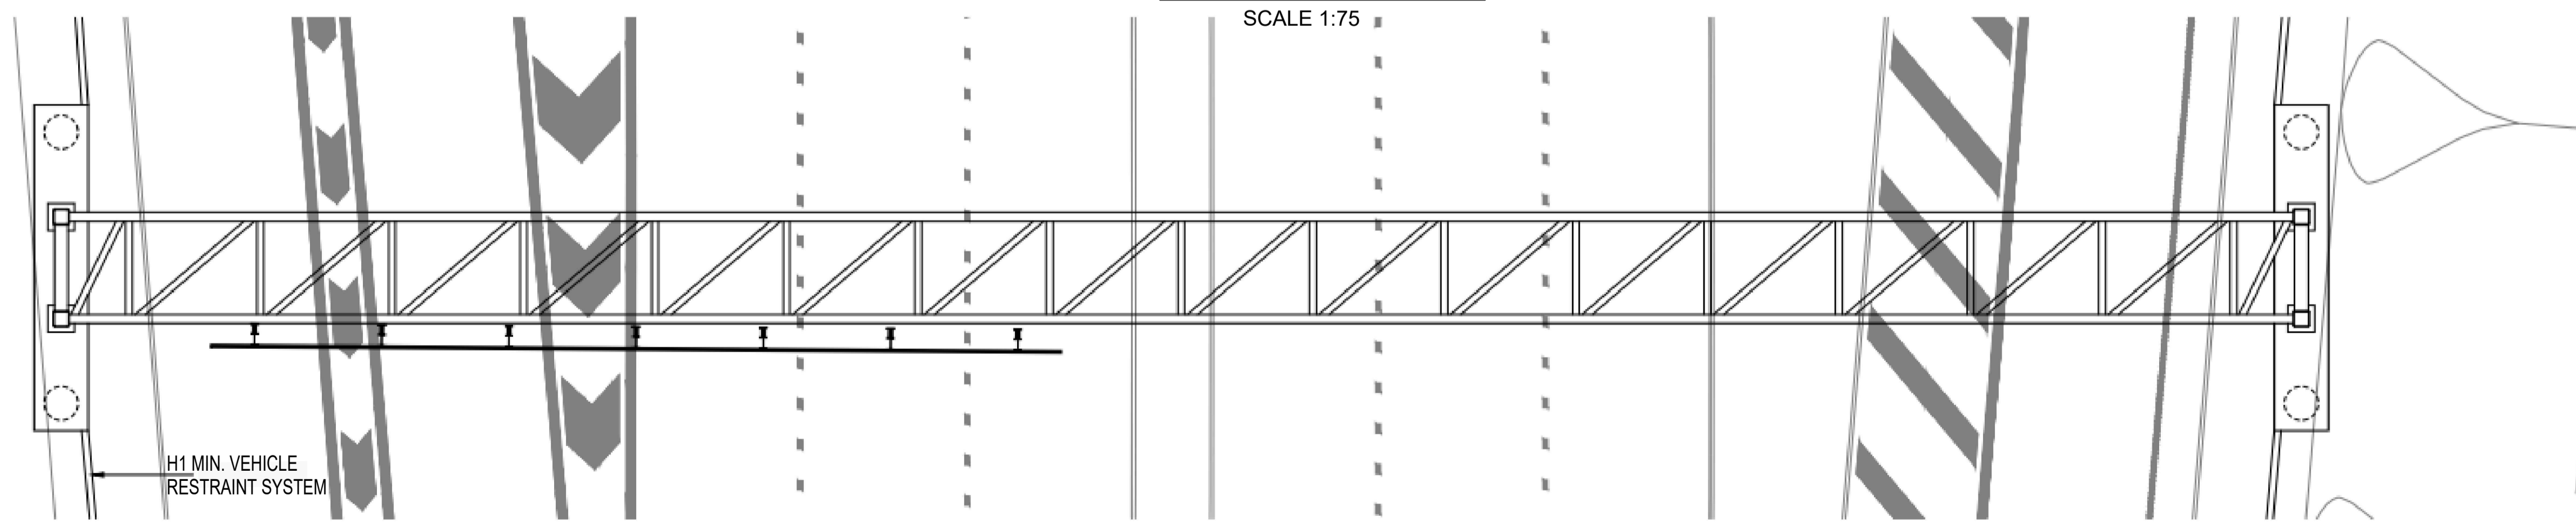

PLAN OF TYPICAL SUPER-SPAN GANTRY

SCALE 1:75

A1 B2C Birtley Coal House

SCALE 1:75 0 750 1500

Rev.	Date	Description	By	Eng' Chk	Disc' Chk	App'd
1	25/02/20	For Examination Deadline 2		RA	IA	IA NR
0	27/09/19	For Application		RA	IA	IA NR

Suitability	Status
For Examination Deadline 2	A3

PINS Reference Number TR010031/APP/2.7(N)



Client A1 BIRTLEY TO COAL HOUSE

Drawing Title STRUCTURES ENGINEERING DRAWINGS & SECTIONS REGULATION 5(2)(o) TYPICAL ADS GANTRY PORTAL TYPE (SHEET 13 OF 14)

Scale	Drawn	Eng. Check	Approved	Authorised
N/A	R.Ayre	I.Akram	I.Akram	N.Rawcliffe
Original Size	Date	Date	Date	Date
A1	25/02/20	25/02/20	25/02/20	25/02/20

Drawing Number	Originator	Volume	Revision			
HE551462	WSP	LSI	1			
Section	Type	ID	Direction	Type	Role	Number
ZZ	DR	ZL	45022			3